

ACTIVITY DETERMINATION

Project No. BGZDZ

Conflict of Interest' In this matter:
 I have declared any possible conflict of interests (real, potential or perceived) to the Acting Chief Executive, Land & Housing Corporation. I do not consider I have any personal interests that would affect my professional judgement. I will inform the Acting Chief Executive, Land & Housing Corporation as soon as I become aware of a possible conflict of interest.
Signed
Emma Nicholson A/Head of Policy and Innovation Land and Housing Corporation, Department of Planning & Environment

Having regard to the Determination Recommendation Report, the Statement of Compliance and the Review of Environmental Factors for this project addressing matters under Part 5 of the *Environmental Planning and Assessment Act 1979*, I determine that the activity proceed as described below and subject to the identified Requirements set out in **Schedule 1**.

SITE IDENTIFICATION							
STREET ADDRESS							
Unit/Street No	Street or property name						
10-16	Albert Street						
Suburb, town or locality Casino		Postcode 2470					
Local Government Area(s) Richmond Valley	Real property description (Lot and D Lots 22,23,24 & 25 in DP 36270	P)					
ACTIVITY DESCRIPTION							
Provide a description of the activity							

Demolition of existing dwellings and structures, removal of trees, and the construction of 17 multidwelling houses comprising 10 x 2 bedroom and 7 x 3 bedroom dwellings, with associated landscaping and fencing, surface parking for 21 cars, and consolidation into a single lot.

^{1.} Conflict of interest includes actual and potential. A conflict of interest includes pecuniary i.e. financial interests to you or a related party or non-pecuniary i.e. benefits to relatives, friends, business associates and personal causes, etc. This includes "related persons" as defined in the Property, Stock and Business Agency Act 2002.

Activity Determination 10-16 Albert Street, Casino

bed Signed.....

18 December 2023 Dated.....

Emma Nicholson A/Head of Policy and Innovation Land and Housing Corporation Department of Planning & Environment

SCHEDULE 1

IDENTIFIED REQUIREMENTS

PART A - Standard Identified Requirements

THE DEVELOPMENT

The following Identified Requirements are to ensure that the residential activity is carried out in accordance with the plans / documents and any amendments arising from the Review of Environmental Factors under Part 5 of the Environmental Planning & Assessment Act 1979, Section 171 of the Environmental Planning and Assessment Regulation 2021 and the requirements of State Environmental Planning Policy (Housing) 2021.

1. The development shall be carried out substantially in accordance with the following plans / documents as modified below and by any of the undermentioned identified requirements:

Title / Name:	Drawing No. / Document Ref	Revision / Issue:	Date [dd/mm/yyyy]:	Prepared by:
Architectural Plans – Apper	ndix A		-	
Location Diagram	A01	A	27/04/2023	Barry Rush & Associates Pty Ltd
Site Analysis Plan	A02	А	27/04/2023	Barry Rush & Associates Pty Ltd
Site Plan	A03	А	27/04/2023	Barry Rush & Associates Pty Ltd
Amended Waste Bin Design	A04	A	24/08/2023	Barry Rush & Associates Pty Ltd
Ground Floor Plan	A04	А	27/04/2023	Barry Rush & Associates Pty Ltd
First Floor Plan	A05	А	27/04/2023	Barry Rush & Associates Pty Ltd
Roof Plan	A06	А	27/04/2023	Barry Rush & Associates Pty Ltd
Elevations	A07	А	27/04/2023	Barry Rush & Associates Pty Ltd
Sections A-A, B-B, C-C & D-D	A08	A	27/04/2023	Barry Rush & Associates Pty Ltd
Sections E-E, F-F, G-G & H-H	A09	A	27/04/2023	Barry Rush & Associates Pty Ltd
Development Data	A10	А	27/04/2023	Barry Rush & Associates Pty Ltd
External Colour & Finishes	A11	А	27/04/2023	Barry Rush & Associates Pty Ltd

Title / Name:	Drawing No. / Document Ref	Revision / Issue:	Date [dd/mm/yyyy]:	Prepared by:					
Schedule									
Block Analysis Plan	A12	A	27/04/2023	Barry Rush & Associates Pty Ltd					
Shadow Diagrams – Mid Winter	A13	А	27/04/2023	Barry Rush & Associates Pty Ltd					
Views from Sun – Mid Winter	A14	A	27/04/2023	Barry Rush & Associates Pty Ltd					
Street Perspective	A15	A	27/04/2023	Barry Rush & Associates Pty Ltd					
Demolition Plan	A16	A	27/04/2023	Barry Rush & Associates Pty Ltd					
Areas of Excavation and Fill	A17	A	27/04/2023	Barry Rush & Associates Pty Ltd					
Landscape Plans – Appendi	хB								
Landscape Plan	LA 1 of 2	В	22/06/2023	Green Land Design					
Landscape Details and Specification	LA 2 of 2	В	22/06/2023	Green Land Design					
Stormwater Plans – Append	Stormwater Plans – Appendix C								
Cover Sheet, Legend and Drawing Schedule	SYD23189- SW000	P1	17/05/2023	Erbas					
Stormwater Services Erosion & Sediment Control Plan	SYD23189- SW001	P1	17/05/2023	Erbas					
Stormwater Services Street Connection Plan	SYD23189- SW100	P2	06/10/2023	Erbas					
Stormwater Services - Ground Floor Plan	SYD23189- SW101	P2	06/10/2023	Erbas					
Stormwater Services - First Floor Plan	SYD23189- SW102	P2	06/10/2023	Erbas					
Stormwater Services - Roof Plan	SYD23189- SW103	P2	06/10/2023	Erbas					
Stormwater Services – Detail Sheet 01	SYD23189- SW201	P1	17/05/2023	Erbas					
Stormwater Services – Detail Sheet 02	SYD23189- SW202	P1	17/05/2023	Erbas					
Stormwater Services – Detail Sheet 03	SYD23189- SW203	P1	17/05/2023	Erbas					
Survey Plans – Appendix D	·		·						
Detail and Level Survey	Sheet 1 of 3	S	06/09/2022	RPS Australia East Pty Ltd					
Detail and Level Survey	Sheet 2 of 3	S	06/09/2022	RPS Australia East Pty Ltd					

Title / Name:	Drawing No. / Document Ref	Revision / Issue:	Date [dd/mm/yyyy]:	Prepared by:
Detail and Level Survey	Sheet 3 of 3	S	06/09/2022	RPS Australia East Pty Ltd
BASIX Certificate – Appendix K	Basix Certification no. 1391454M	-	18/05/2023	Building Sustainability Assessments
NatHERS Certificate – Appendix L	Certificate No 0008653250	-	18/05/2023	Building Sustainability Assessments
Hydrant Coverage – Append	dix S			
	SKH01	А	30/08/2023	Erbas
	SKH02	A	30/08/2023	Erbas
	SKH02	А	30/08/2023	Erbas
Specialist Reports				
Arboricultural Impact Assessment – Appendix J	F420	A	22/05/2023	Creative Planning Solutions
BCA Design Compliance Assessment - Appendix H	P230082	1	18/05/2023	BCA vision
Geotechnical Investigation - Appendix O	31897/6742D-G	-	September 2022	STS Geotechnics Pty Ltd
Traffic Impact Assessment- Appendix R	-	-	May 2023	Fernway Engineering
Waste Minimisation and Management Plan – Appendix P	-	-	18/05/2023	Barry Rush & Associates Pty Ltd

- **2.** All building work is to be undertaken in accordance with the National Construction Code and referenced Australian Standards.
- **3.** All commitments listed in the BASIX certificate and stamped plans shall be implemented.
- **4.** All construction documentation and building work is to be certified in accordance with Section 6.28 of the Environmental Planning and Assessment Act 1979.
- 5. The land the subject of this determination shall be consolidated into a single lot. The plan of consolidation shall be lodged at the NSW Land Registry Services and shall be registered prior to the occupation of the development. A copy of the registered plan shall be provided to the Land & Housing Corporation.

OPERATIONAL MATTERS

The following Identified Requirements relate to the use of the site and are to ensure that the activity and its operation do not interfere with the amenity of the surrounding area.

Stormwater Run-off

- 6. Stormwater shall be collected within the site and conveyed in a pipeline to the appropriate gutter or drain under the control of Richmond Valley Council substantially in accordance with the approved concept stormwater drainage plans.
- 7. Alterations to the natural surface contours or surface absorption characteristics of the site shall not impede, increase or divert natural surface water runoff so as to cause a nuisance to adjoining property owners.
- 8. All driveways shall be graded in such a manner as to provide continuous surface drainage flow paths to the appropriate points of discharge.
- **9.** To prevent water from entering buildings, surface waters shall be collected and diverted clear of the buildings by a sub-surface / surface drainage system.

Vehicular Access & Parking

- **10.** Concrete vehicular crossings and laybacks shall be provided at the entrances / exits to the property. The crossings and laybacks shall be constructed in accordance with Richmond Valley Council's standard requirements for residential crossings. Council shall be provided with plans for the crossings and laybacks together with the payment of any council inspection fees.
- 11. Particular care shall be taken in the location of vehicular crossings and/or laybacks to avoid poles, pits etc. The cost of any necessary adjustments to utility mains and services associated with the construction of the laybacks / driveways shall be borne by the Land & Housing Corporation. Obsolete gutter laybacks shall be removed and the roadway reconstructed in accordance with Richmond Valley Council's standards.

Note:

It is recommended that discussion be held with the relevant authorities before construction works commence.

12. Car parking spaces and driveways shall be constructed of concrete or other approved hard surfaced materials. The spaces must be clear of obstructions and columns, permanently line marked and provided with adequate manoeuvring facilities. The design of these spaces must comply with AS 2890.1.

Site Works

13. All soil erosion and sediment control measures required to be put in place prior to the commencement of demolition / construction works shall be maintained during the entire period of the works until all the disturbed areas are restored by turfing, paving or revegetation. Soil erosion and sediment control measures shall be designed in accordance with the guidelines set-out in the Blue Book *Managing Urban Stormwater: Soils and Construction* (4th edition, Landcom, 2004).

14. An appropriately qualified person shall design retaining walls or other methods necessary to prevent the movement of excavated or filled ground, including associated stormwater drainage measures.

Building Siting

15. All buildings shall be sited well clear of any easements affecting the site. The builder shall ascertain if any easements do exist and, if they do, obtain full details of such prior to construction commencing.

Smoke Detection System(s)

- **16.** Smoke detection systems shall be installed throughout the buildings in accordance with requirements of Clause E2.2a of the Building Code of Australia. Detectors and alarms shall comply with AS 3786 and AS 1670 and must:
 - i. be connected to a permanent 240V power supply; and
 - ii. be provided with a battery backup to activate the alarm unit in the event of failure of the permanent power supply.

Site Soil Contamination

17. If the site is identified as being potentially affected by soil contamination, it shall be inspected by a suitably qualified person to identify any contaminated or hazardous material present. A proposal for remediation shall be prepared, which may include preparation of a Remedial Action Plan, and remediation shall be carried out in accordance with the proposal. A Validation Report, prepared in accordance with Environment Protection Authority requirements, shall be obtained from a qualified expert on completion of the remediation work to verify that the site is suitable for the intended residential use. A copy of the Validation Report shall be provided to the Land & Housing Corporation on completion of the remediation works.

Landscaping

- **18.** Landscaping shall be carried out substantially in accordance with the approved landscape plan(s) and maintained for a period of 12 months by the building contractor. Richmond Valley Council shall be consulted in relation to the planting of any street trees.
- **19.** All scheduled plant stock shall be pre-ordered, prior to commencement of construction or 3 months prior to the commencement of landscape construction works, whichever occurs sooner, for the supply to the site on time for installation. The builder shall provide written confirmation of the order to the Land & Housing Corporation.

Tree Removal

20. Removal of trees within the boundaries of the site is to be carried out in accordance with the trees shown for removal on the approved Landscape Plan and Arboricultural Impact Assessment report and no other trees shall be removed without further approval(s).

Fencing

21. All front fencing and gates shall be constructed wholly within the boundaries of the site. Any gates associated with the fencing shall swing inwards towards the site.

Provision of Letterbox Facilities

22. Suitable letterbox facilities are to be provided in accordance with Australia Post specifications.

Public Liability Insurance

23. A valid public liability insurance policy of at least \$10M shall be maintained throughout the demolition / construction works by the contractor.

PRIOR TO ANY WORK COMMENCING ON THE SITE

The following Identified Requirements are to be complied with prior to any work commencing on the site, including demolition.

Disconnection of Services

- 24. All services that are required to be disconnected shall be appropriately disconnected and made safe prior to commencement of the demolition / construction works. The various service authorities shall be consulted regarding their requirements for the disconnection of services.
- **25.** All existing services within the boundary to remain live shall be identified, pegged and made safe.

Demolition

- 26. The builder shall notify the occupants of premises on either side, opposite and at the rear of the site a minimum of 5 working days prior to demolition. Such notification shall be clearly written on an A4 size paper giving the date demolition will commence and be placed in the letterbox of every premise (including every unit in a multi-unit residential building or mixed use building). The demolition shall not commence prior to the date that is stated in the notice letter.
- 27. Prior to the demolition, a Work Plan shall be prepared by a competent person(s) in accordance with AS 2601 and shall be submitted to the Land & Housing Corporation. The Work Plan shall outline the identification of any hazardous materials (including surfaces coated with lead paint), method of demolition, the precautions to be employed to minimise any dust nuisance and the disposal methods for hazardous materials.
- 28. If buildings to be demolished are determined as, or suspected of, containing asbestos cement, a standard commercially manufactured sign containing the words 'DANGER ASBESTOS REMOVAL IN PROGRESS', and measuring not less than 400mm x 300mm, shall be erected in a prominent visible position on the site for the duration of the demolition works.

Note:

Any buildings constructed before 1987 is assumed to contain asbestos.

Utilities Service Provider Notification

29. The demolition / construction plans shall be submitted to the appropriate water utility's office (e.g. Richmond Valley Council or Sydney Water office) to determine whether or not the development will affect the utility's sewer and water mains, stormwater drains and any easements.

Note:

If the development complies with water utility's requirements, the plans will be stamped indicating that no further requirements are necessary.

Council Notification

30. Richmond Valley Council shall be advised in writing, of the date it is intended to commence work, including demolition. A minimum period of **5** working days notification shall be given.

Site Safety

- **31.** A sign shall be erected in a prominent position on any site on which demolition or building work is being carried out:
 - (a) showing the name, address and telephone number of the responsible Land & Housing Corporation officer for the work, and
 - (b) showing the name of the principal contractor (if any) and a telephone number on which that person may be contacted outside working hours, and
 - (c) stating that unauthorised entry to the work site is prohibited.

The sign shall be maintained while the work is being carried out but shall be removed when the work has been completed.

Note:

This requirement does not apply in relation to building work that is carried out inside an existing building that does not affect the external walls of the building.

32. A minimum 1.8m high security fence or Class A / Class B (overhead) hoarding must be erected between the work site and any public place prior to demolition / construction. Access to the site shall be restricted to authorised persons only and the site shall be secured against unauthorised entry when demolition / construction work is not in progress or the site is otherwise unoccupied.

Note:

Approval from the relevant roads authority will be required under Section 138 of the Roads Act 1993 where a Class A or B hoarding encroaches onto the footpath of / or a public thoroughfare within a classified road.

33. No building or demolition materials are to be stored on the footpath or roadway.

Site Facilities

- **34.** The following facilities shall be installed on the site:
 - (a) Toilet facilities shall be provided at the rate of 1 toilet for every 20 persons or part thereof employed at the site. Each toilet provided shall be a standard flushing toilet and shall be connected to a public sewer or if connection to a public sewer is not practicable, to an accredited sewerage management facility provided by

Richmond Valley Council or if this is not practicable to some other council approved management facility.

- (b) Adequate refuse disposal methods and builders storage facilities. Builders' wastes, materials or sheds shall not to be placed on any property other than that which this approval relates to.
- **35.** Access to the site shall only be provided via an all-weather driveway on the property and is not to be provided from any other site.

Protection of Trees

36. Trees and other vegetation that are to be retained on site shall be protected prior to the commencement of works and for the duration of the construction period in accordance with the details provided in the Arboricultural Impact Assessment report.

Waste Management

37. A final Waste Management Plan shall be prepared and submitted to the Land & Housing Corporation by the building contractor prior to the commencement of demolition / construction. The plan shall detail the amount of waste material and the destination of all materials, recyclable and non-recyclable.

PRIOR TO ANY CONSTRUCTION WORK COMMENCING ON SITE

The following Identified Requirements are to be complied with prior to any construction works occurring on the site, excluding demolition.

Service Authority Clearances

38. A compliance certificate, or other evidence, shall be obtained from the relevant water utility provider (e.g. Richmond Valley Council), confirming service availability prior to work commencing.

Note:

Payment of water and/or sewer service charges and/or a notice of requirements for works to be carried out during construction / prior to occupation may be applicable prior to issue of the compliance certificate.

- **39.** A written clearance from an electricity supply authority stating that electrical services are available to the site, or that arrangements have been entered into for the provision of services to the site, shall be obtained prior to work commencing.
- **40.** A certificate from an approved telecommunications carrier certifying that satisfactory arrangements have been made for the provision of underground telephone services, to the site and to each dwelling, shall be obtained prior to work commencing.
- **41.** Where the site is to be connected to reticulated gas, a certificate from an approved gas carrier to certify that satisfactory arrangements have been made to ensure the provision of underground gas services to each dwelling in the development shall be obtained prior to work commencing.

Stormwater Disposal

- **42.** A detailed stormwater drainage plan(s), substantially in accordance with the approved concept stormwater drainage plan(s), shall be prepared and submitted to the Land & Housing Corporation. Any on-site detention system shall be designed in accordance with the relevant catchment authority's requirements (e.g. the Upper Parramatta River Catchment Trust On-site Detention Handbook) and/or Richmond Valley Council's drainage code.
- **43.** Where a drainage easement is required, proof of lodgement of the plan of the drainage easement at the NSW Land Registry Services shall be submitted to the Land & Housing Corporation prior to commencement of works. Registration of the plan of easement shall be completed prior to occupation of the development and a copy of the registered plan shall be provided to the Land & Housing Corporation.

DURING DEMOLITION AND CONSTRUCTION WORKS

The following Identified Requirements are to be complied with whilst demolition and construction works are occurring on the site.

Landfill

- **44.** Where site filling is necessary, a minimum of 95% standard compacting shall be achieved and certified by a NATA registered Soils Lab.
- **45.** Land fill materials must satisfy the following requirements:
 - i. be Virgin Excavated Natural Matter (VENM);
 - ii. be free of slag, hazardous, contaminated, putrescible, toxic or radio-active matter; and
 - iii. be free of industrial waste and building debris.

Heritage

- **46.** Historic and indigenous archaeological sites and relics are protected under the *Heritage Act 1977* and *National Parks and Wildlife Act 1974,* respectively. Should any relics be uncovered during the course of the approved works, work must cease immediately in the affected area. Subsequently, in cases where historical items have been uncovered, the Department of Planning and Environment must be contacted.
- **47.** All workers / contractors on the site shall be informed of their obligations, under the Heritage Act and *National Parks and Wildlife Act 1974*, that it is illegal to disturb, damage or destroy a relic without the prior approval.

Demolition

- **48.** Any existing structures identified for demolition shall be demolished prior to commencement of the construction of the activity.
- **49.** Demolition shall be carried out in accordance with the appropriate provisions of AS 2601.
- **50.** Where materials containing asbestos are to be removed, demolition shall be carried out by a licensed contractor(s) who have current SafeWork NSW accreditation in asbestos removal.

- **51.** Removal of asbestos-based thermal or acoustic insulation, such as sprayed asbestos and asbestos-based lagging, including friable asbestos boards, shall be carried out in accordance with the National Occupational Health and Safety Commission's Code of Practice for the Safe Removal of Asbestos, 2nd Edition [NOHSC:2002 (2005)].
- **52.** Hazardous or intractable wastes, including all asbestos laden waste, arising from the demolition process shall be removed and disposed of in accordance with the requirements of SafeWork NSW and the Department of Planning and Environment.
- **53.** Documentary evidence, in the form of tip receipts from an approved Waste Management Facility, shall be obtained by the demolition contractor and submitted to the Land & Housing Corporation demonstrating the appropriate disposal of the asbestos waste.
- **54.** Demolition procedures shall maximise the reuse and recycling of demolished materials in order to reduce the environmental impacts of waste disposal.
- **55.** During demolition, the public footpath and the public road shall not be obstructed by any vehicles. The public road and footpath shall be swept (not hosed) clean of any material, including clay, soil and sand.
- **56.** All vehicles leaving the site with demolition materials shall have their loads covered and vehicles shall not track soil and other material onto the public roads and footpaths. The footpath shall be suitably protected against damage when plant and vehicles access the site. All loading of vehicles with demolished materials shall occur on site.

Survey Reports

57. Survey reports shall be submitted by the building contractor to the Land & Housing Corporation prior to the placement of the footings / slab and on completion of the dwellings to verify the correct position of the structures in relation to the allotment boundaries.

Hours of Demolition / Construction / Civil Work

58. Demolition / construction / civil work shall only occur on the site between the hours of 7.00am to 5.00pm Monday to Saturday with no work permitted on Sundays or public holidays.

Excavation & Backfilling

59. All excavations and backfilling associated with the demolition or erection of building(s) shall be executed safely and in accordance with appropriate professional standards. All such work shall be guarded and protected to prevent it from being dangerous to life or property.

Pollution Control

- **60.** Any noise generated during the construction of the development shall not exceed the limits specified in the July 2009 Interim Construction Noise Guidelines, published by the former Department of Environment and Climate Change.
- 61. No fires shall be lit or waste materials burnt on the site.

- 62. No washing of concrete forms or trucks shall occur on the site.
- **63.** Any contamination / spills on the site during construction works shall be actively managed and reported immediately to appropriate regulatory authorities to minimise any potential damage to the environment.
- **64.** Dust generation during demolition / construction shall be controlled using regular control measures such as on site watering or damp cloth fences.
- **65.** All vehicles transporting loose materials and travelling on public roads shall be secured (i.e. closed tail gate and covered) to minimise dust generation.
- **66.** Non-recyclable waste and containers shall be regularly collected and disposed of at a licensed landfill or other disposal site in accordance with details set out in the final Waste Management Plan.

Impact of Construction Works

- **67.** The Land & Housing Corporation shall bear the cost of any necessary adjustments to utility mains and services.
- **68.** Care shall be taken to prevent any damage to adjoining properties. The building contractor shall be liable to pay compensation to any adjoining owner if, due to demolition/construction works, damage is caused to such adjoining property.

Termite Protection

69. To protect buildings from subterranean termite, termite barriers installed in accordance with AS 3660.1, shall be placed on the underside and in penetrations of the concrete slab floor.

In addition, a durable notice must be permanently fixed inside the meter box indicating:

- (a) the method of protection,
- (b) the date of installation of the system,
- (c) where a chemical barrier is used, its life expectancy as listed on the National Registration Authority label, and
- (d) the need to maintain and inspect the system on a regular basis.

PRIOR TO OCCUPATION OF THE DEVELOPMENT

The following Identified Requirements are to be complied with prior to the occupation of the development.

General

70. The use or occupation of the development shall not commence until all the Identified Requirements of this determination have been complied with.

Council Infrastructure Damage

71. The cost of repairing any damage caused to Richmond Valley Council's assets in the vicinity of the site as a result of demolition / construction works shall be met in full by the building contractor.

Stormwater Drainage

- 72. Prior to occupation, a Work As Executed Plan shall be prepared by the building contractor clearly showing all aspects of the constructed stormwater drainage system, including any on-site detention system. The plan shall demonstrate general compliance with the approved concept stormwater drainage plan(s) and shall include:
 - sufficient levels and dimensions to verify the constructed storage volumes; and
 - location and surface levels of all pits; and
 - invert levels of the internal drainage lines, orifice plates fitted and levels within the outlet control pits; and
 - finished floor levels of all structures; and
 - verification that any required trash screens have been installed; and
 - locations and levels of any overland flow paths; and
 - verification that any drainage lines are located wholly within easements, where applicable.

The Work-As-Executed Plan information shall be shown on the final civil works drawings.

A positive covenant and restriction-as-to-user shall be placed over the onsite detention system in accordance with Richmond Valley Council's on-site detention policy to ensure that the system will be adequately maintained. The positive covenant and restriction-as-to-user shall be registered at NSW Land Registry Services prior to occupation. A copy of the registered restriction-as-to-user shall be provided to the Land & Housing Corporation and Richmond Valley Council.

PART B - Additional Identified Requirements

Site Specific Requirements

73. Nil requirements.

Requirements Resulting from Council Comments

74. Sewer

Prior to the commencement of construction works an investigative survey is to be undertaken to identify the location of the sewer main. This main is to remain and there is to be no structure, footing, overhang or new tree planting within 1.5m of the centreline of the sewer main.

Existing Sewer connections no longer used must be capped at the boundary. If sewer junctions are not utilised they must be removed.

A 3m wide easement (1.5m either side of the sewer pipe) is to be created over the existing sewer main and registered with the consolidation of the 4 allotments.

75. Stormwater

Access to the stormwater detention tank and rainwater storage must be locked to prevent unauthorised access.

76. Developer Contributions

In accordance with Section 64 of the Local Government Act, 1993 and Chapter 6 Part 2 Division 5 of the Water Management Act, 2000 for Water and Sewer Headworks Services area payable to Richmond Valley Council (RVC) prior to the commencement of works.

Section 64 Contributions payable are:

Section 64 Local Govt Act & Water Management Act 2000 Levy Area - Casino	TechOne Code	No. of ET's	\$ / ET for 2023-2024	Amount Payable (\$)
RVC Water Headworks	WatS64Hwks	7.6	\$ 9,630.50	\$ 71,139.80
RVC Sewerage Headworks	SewS64Hwks	10.5 \$ 8,000.00		\$ 84,000.00
Rous Water #Water Headworks	Rous64Hwks	N/A N/A		\$ NIL
Total Section (current @ 8/8/2023 but generally ap Payments will be in accordance with C	\$155,139.80			

77. Waste Storage

Prior to the commencement of construction all architectural plans (Appendix A), landscape plans (Appendix B) and stormwater/civil engineering plans (Appendix C) must be amended to ensure consistency with the Amended Waste Bin Design Plan Sheet A04 dated 24 August 2023 by *Barry Rush and Associates* with regard to the location and dimensions of waste storage areas.

78. Fire Hydrant Coverage

Prior to the commencement of construction an enquiry is to be lodged with Richmond Valley Council to determine the pressure and flow data for the Fire Hydrant coverage.

79. Driveway crossing and works in the road reserve:

All driveway crossings are to have a splay at the point of conection with the road pavement to protect the edge of the pavement from vehicle movements.

Prior to any works in the Albert Street road reserve the building contractor shall consult Richmond Valley Council, to ensure that the design is in accordance with Council requirements. These works may include works such as construction of vehicle crossings, services, and other infrastructure.

ADVISORY NOTES

- i. Approval of this development activity does not imply or infer compliance with Section 23 of the *Disability Discrimination Act 1992*. Refer to AS 1428.1 and the Building Code of Australia for detailed guidance.
- ii. Information regarding the location of underground services may be obtained from Dial Before You Dig at <u>www.1100.com.au</u> or by dialing 1100.



Decision Statement

Project No. BGZDZ

SITE IDENTIFICATION		
STREET ADDRESS		
Unit/Street No	Street or property name	
10-16	Albert Street	
Suburb, town or locality		Postcode
Casino		2470
Local Government Area(s)	Real property description (Lot and DP)	1
Richmond Valley	Lots 22,23,24 & 25 in DP 36270	

ACTIVITY DESCRIPTION

Provide a description of the activity

Demolition of existing dwellings and structures, removal of trees, and the construction of 17 multidwelling houses comprising 10 x 2 bedroom and 7 x 3 bedroom dwellings, with associated landscaping and fencing, surface parking for 21 cars, and consolidation into a single lot.

The Land & Housing Corporation (LAHC) has proposed the above activity under the provisions of *State Environmental Planning Policy (Housing) 2021* (Housing SEPP) which requires determination under Part 5 of the *Environmental Planning & Assessment Act 1979* (EP&A Act). This Decision Statement relates to the Review of Environmental Factors (REF) for the above activity prepared under Part 5 of the EP&A Act and the *Environmental Planning and Assessment Regulation 2021*.

Based on the REF document and supporting documentation, including advice from Richmond Valley Council a decision to proceed with the proposed activity has been made. This decision included consideration of the following:

Significant Impact on the Environment

- The proposed activity is not likely to have a significant impact on the environment and therefore an EIS is not required.
- The proposed activity will not be carried out in a declared area of outstanding biodiversity value and is not likely to significantly affect threatened species, populations or ecological communities, or their habitats or impact biodiversity values, meaning a SIS and/or BDAR is not required.

Reasons for the Decision

 Following an assessment of the proposed activity and associated environmental impacts within the REF document it was decided that the proposed development will have economic and social benefits and any minor short-term impacts on the environment or surrounding properties can be appropriately mitigated. • The proposed development will assist in the provision of much needed social and affordable housing and assist in addressing the existing and growing demand for housing in the Richmond Valley local government area.

Mitigation Measures

• Mitigation measures are required to minimise or manage environmental impacts and are detailed throughout the REF and specifically within Section 7. All mitigation measures are detailed as Identified Requirements within the Activity Determination. Additional mitigation measures, detailed in the Activity Determination have been imposed to minimise the impact on the surrounding environment, ensure appropriate site safety and to ensure legislative compliance.

Signed.....

18 December 2023
Dated.....

Emma Nicholson Acting Head of Policy and Innovation Land and Housing Corporation Department of Planning & Environment

0 5 10 20 SCALE FOR PRINTING PURPOSE ONLY 40MM

DETERMINED by the NSW Land and Housing Corporation on: DA PLANS **GENERAL HOUSING DEVELOPMENT** 10 - 16 ALBERT STREET, CASINO

LOTS 22, 23, 24 & 25 in DP 36270



LOCATION DIAGRAM



STREET PERSPECTIVE






DRAWING SCHEDULE

ARCHITECTURAL	REFERENCE	E No
COVER PAGE	A01	-
SITE ANALYSIS PLAN	A02	-
SITE PLAN	A03	-
GROUND FLOOR PLAN	A04	-
FIRST FLOOR PLAN	A05	-
ROOF PLAN	A06	-
ELEVATIONS	A07	-
SECTIONS A-A, B-B, C-C & D-D	A08	-
SECTIONS E-E, F-F, G-G & H-H	A09	-
DEVELOPMENT DATA	A10	-
FINISHES SCHEDULE	A11	-
BLOCK ANALYSIS PLAN	A12	-
SHADOW DIAGRAMS MID WINTER	A13	-
VIEWS FROM SUN DIAGRAM	A14	-
STREET PERSPECTIVE	A15	-
DEMOLITION PLAN	A16	-
AREAS OF EXCAVATION & FILL	A17	-
CIVIL COVER SHEET, LEGEND & DRAWING SCHEDULE EROSION & SEDIMENT CONTROL PLAN STREET CONNECTION PLAN GROUND FLOOR PLAN FIRST FLOOR PLAN ROOF PLAN DETAILS SHEET 1 DETAILS SHEET 2 DETAILS SHEET 3	SW000 SW001 SW100 SW102 SW103 SW201 SW202 SW203	P1 P1 P1 P1 P1 P1 P1
LANDSCAPE LANDSCAPE PLAN LANDSCAPE DETAILS & SPECIFICATION	LA 1 OF 2 LA 2 OF 2	B B
SURVEY DETAIL AND LEVEL SURVEY DETAIL AND LEVEL SURVEY DETAIL AND LEVEL SURVEY	SHT 1 OF 3 SHT 2 OF 3 SHT 3 OF 3	
BY: RPS AUSTRALIA EAST PTY LTD		


SURVEY REFERENCE 151687 DATE 06/09/2022


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			27/04/23					
			STAGE:	DRAWN:	CHECKED:	NOMINATED ARCHITECT:		
				мв	BR	BR		
	RLE:	PLOTTED:	TYPE:	SHEET:		REV:		
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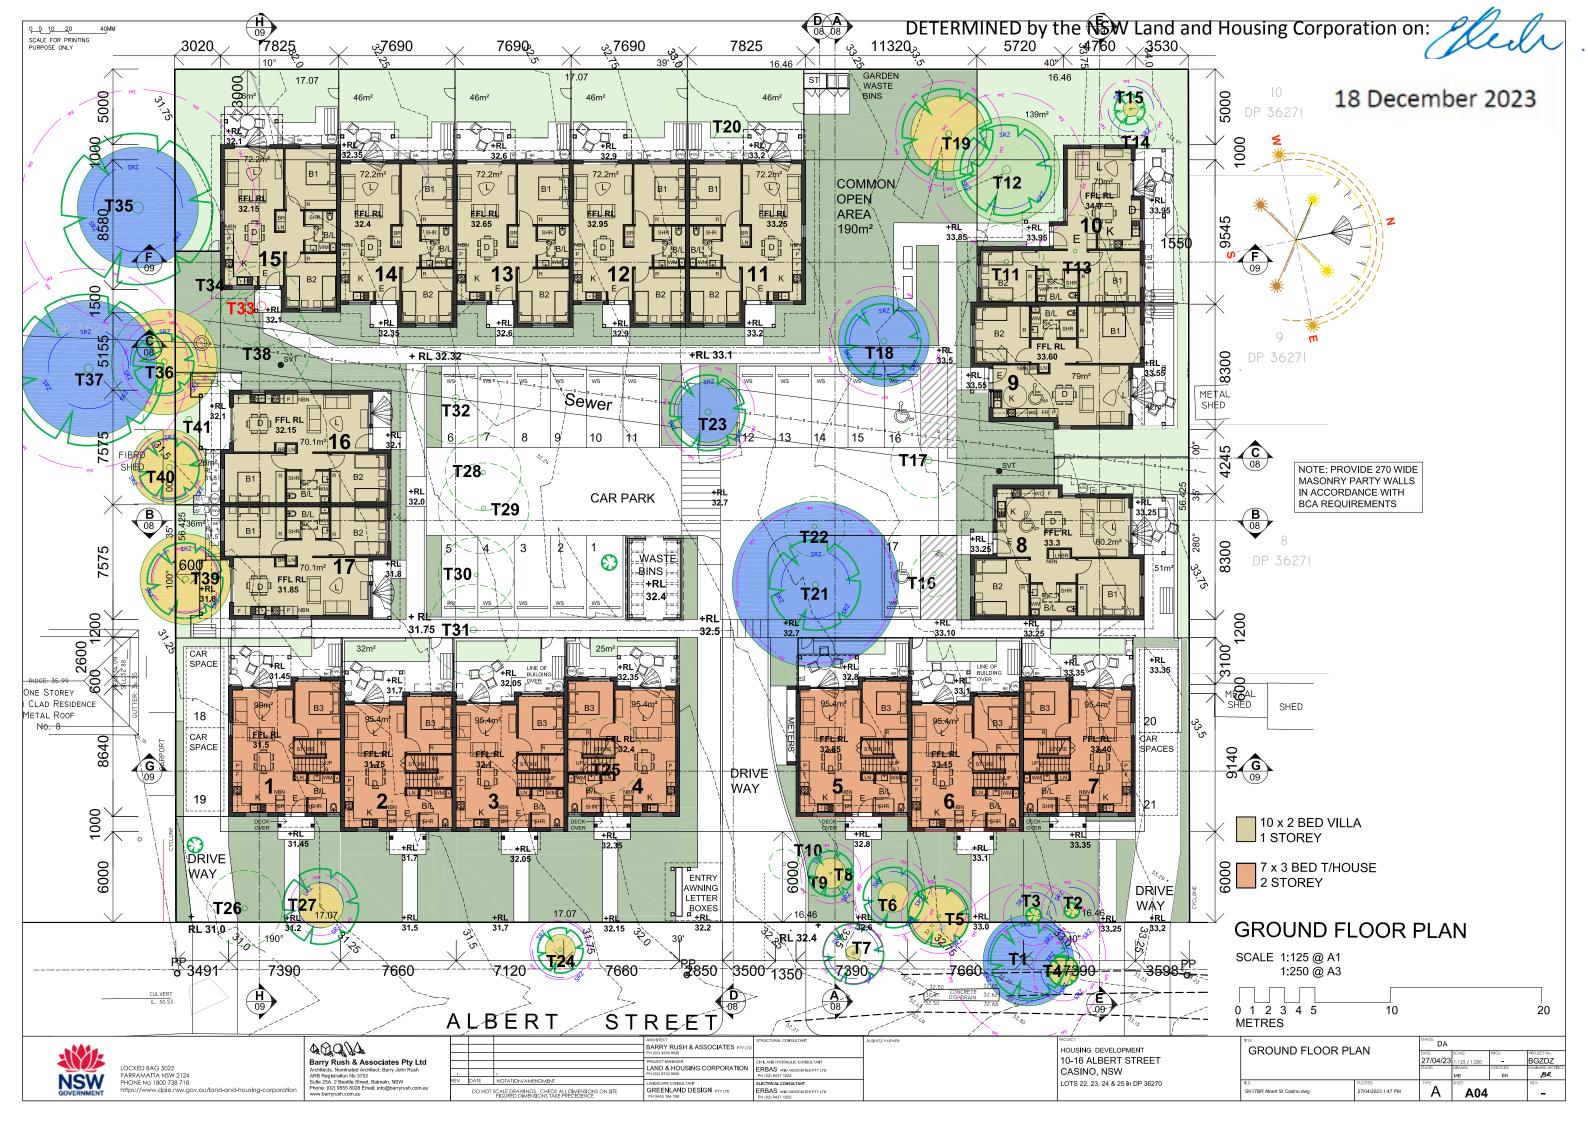


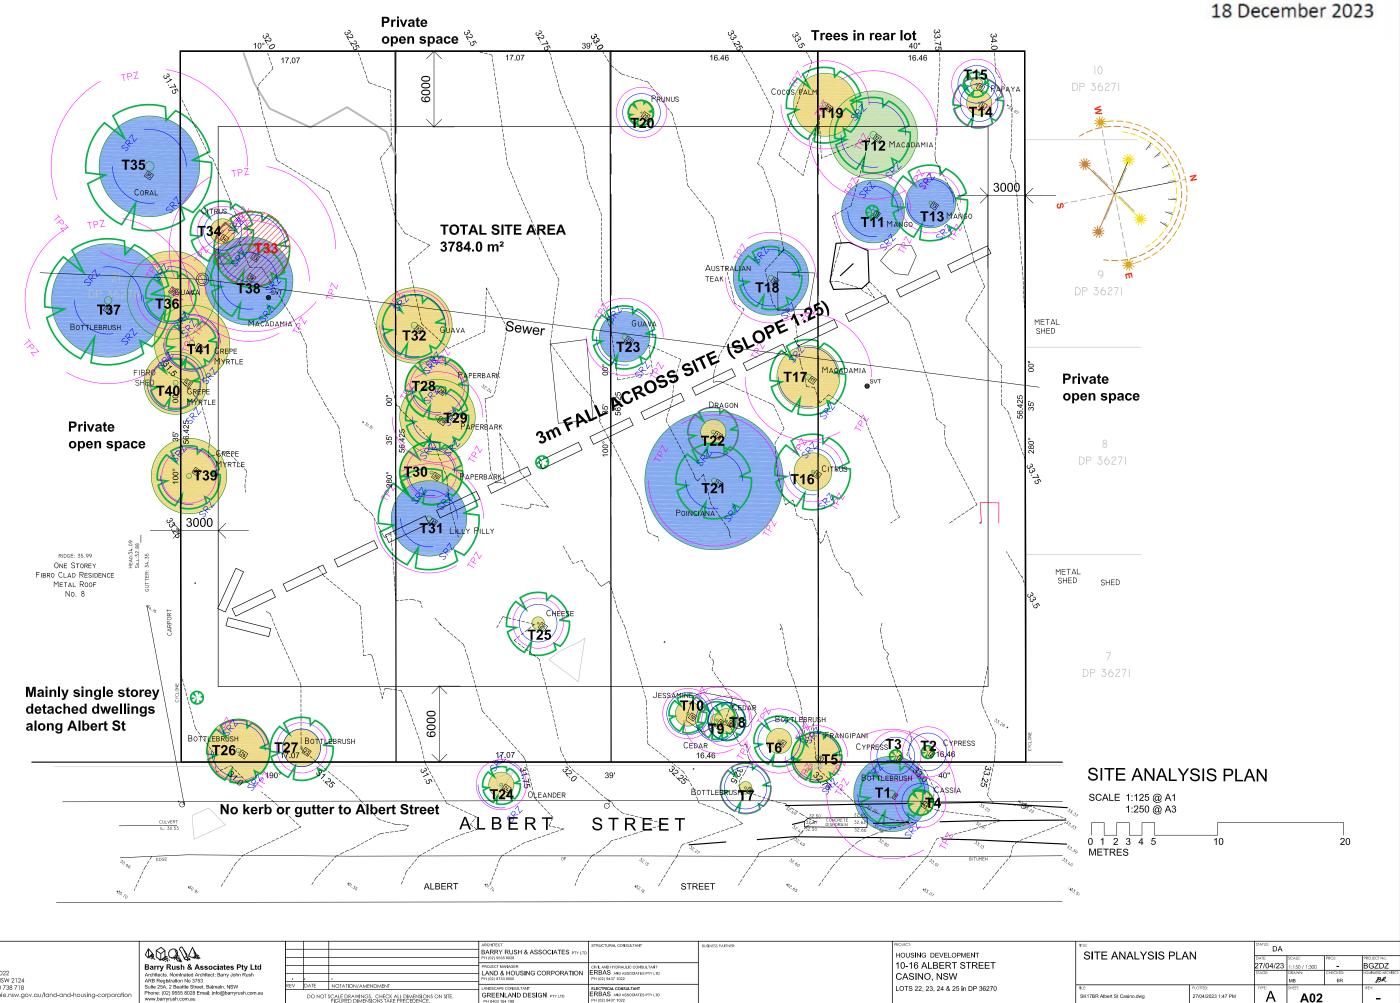
	40010		BARRY RUSH & ASSOCIATES PTYLTD PH (02) 9555 8028		BUGINESS PARTNER:	PROJECT: HOUSING DEVELOPMENT 10-16 ALBERT STREET
LOCKED BAG 5022 PARRAMATIA NSW 2124	Barry Rush & Associates Pty Ltd Architects. Nominated Architect: Barry John Rush ARB Registration No 3753		LAND & HOUSING CORPORATION	CIVE AND HYDRAULIC CONSULTANT ERBAS AND ASSOCIATES PTY LTD PH (02) 9437 1022		CASINO, NSW
PHONE No 1800 738 718 https://www.dpie.nsw.gov.au/land-and-housing-corporation	Sulte 25A, 2 Beattle Street, Balmain, NSW Phone: (02) 9555 8028 Email: info@barryrush.com.au www.barryrush.com.au	DO NOT SCALE DRAWINGS. CHECK ALL DIMENSIONS ON SITE.	GREENLAND DESIGN PTY LTD	ELECTRICAL CONSULTANT ERBAS AND ASSOCIATES PTY LTD PH (02) 9437 1022		LOTS 22, 23, 24 & 25 in DP 36270





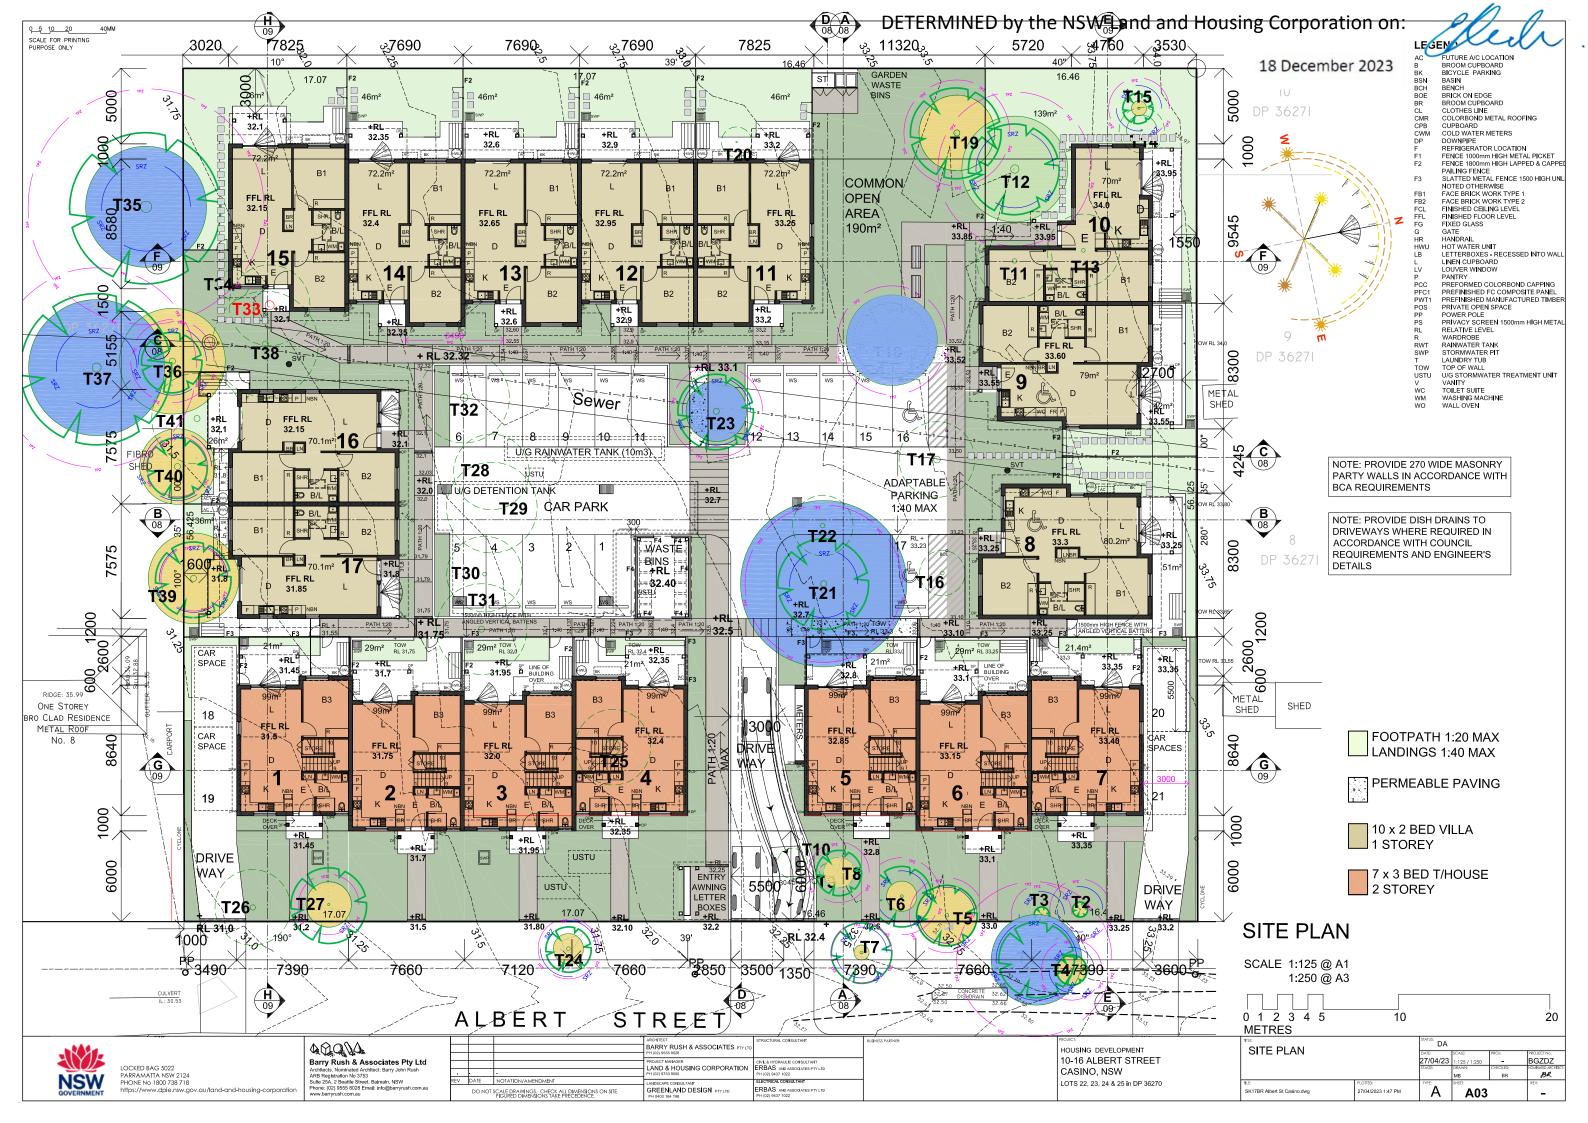

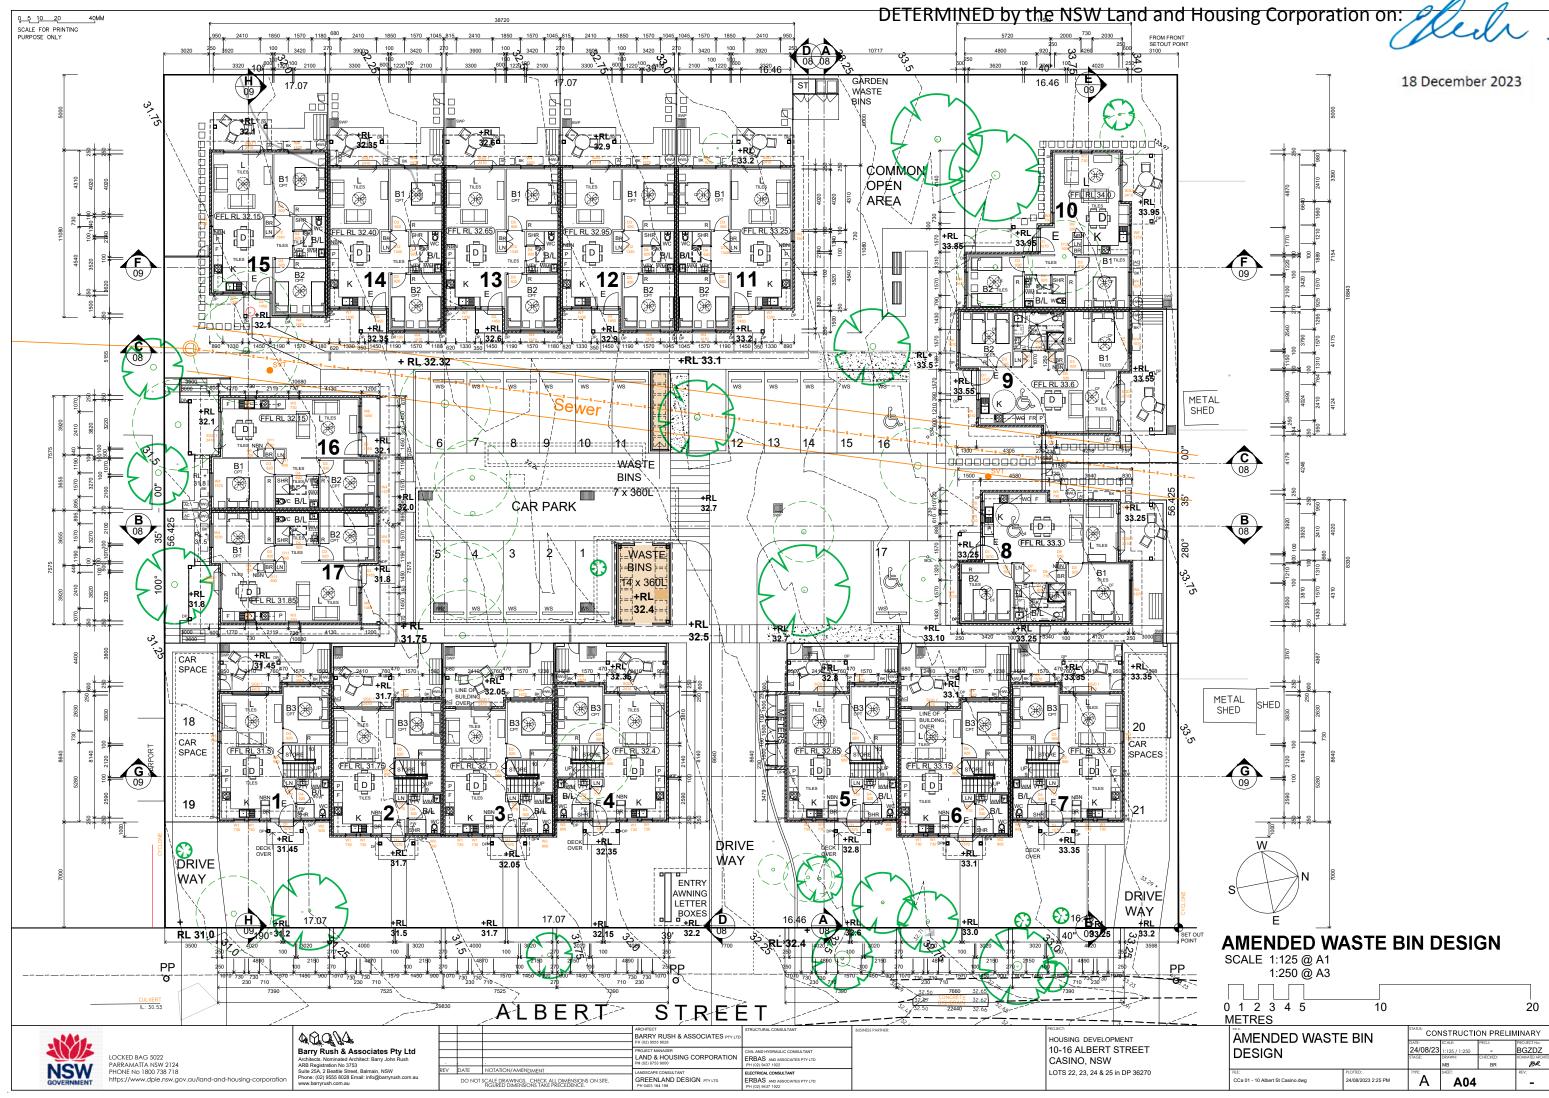


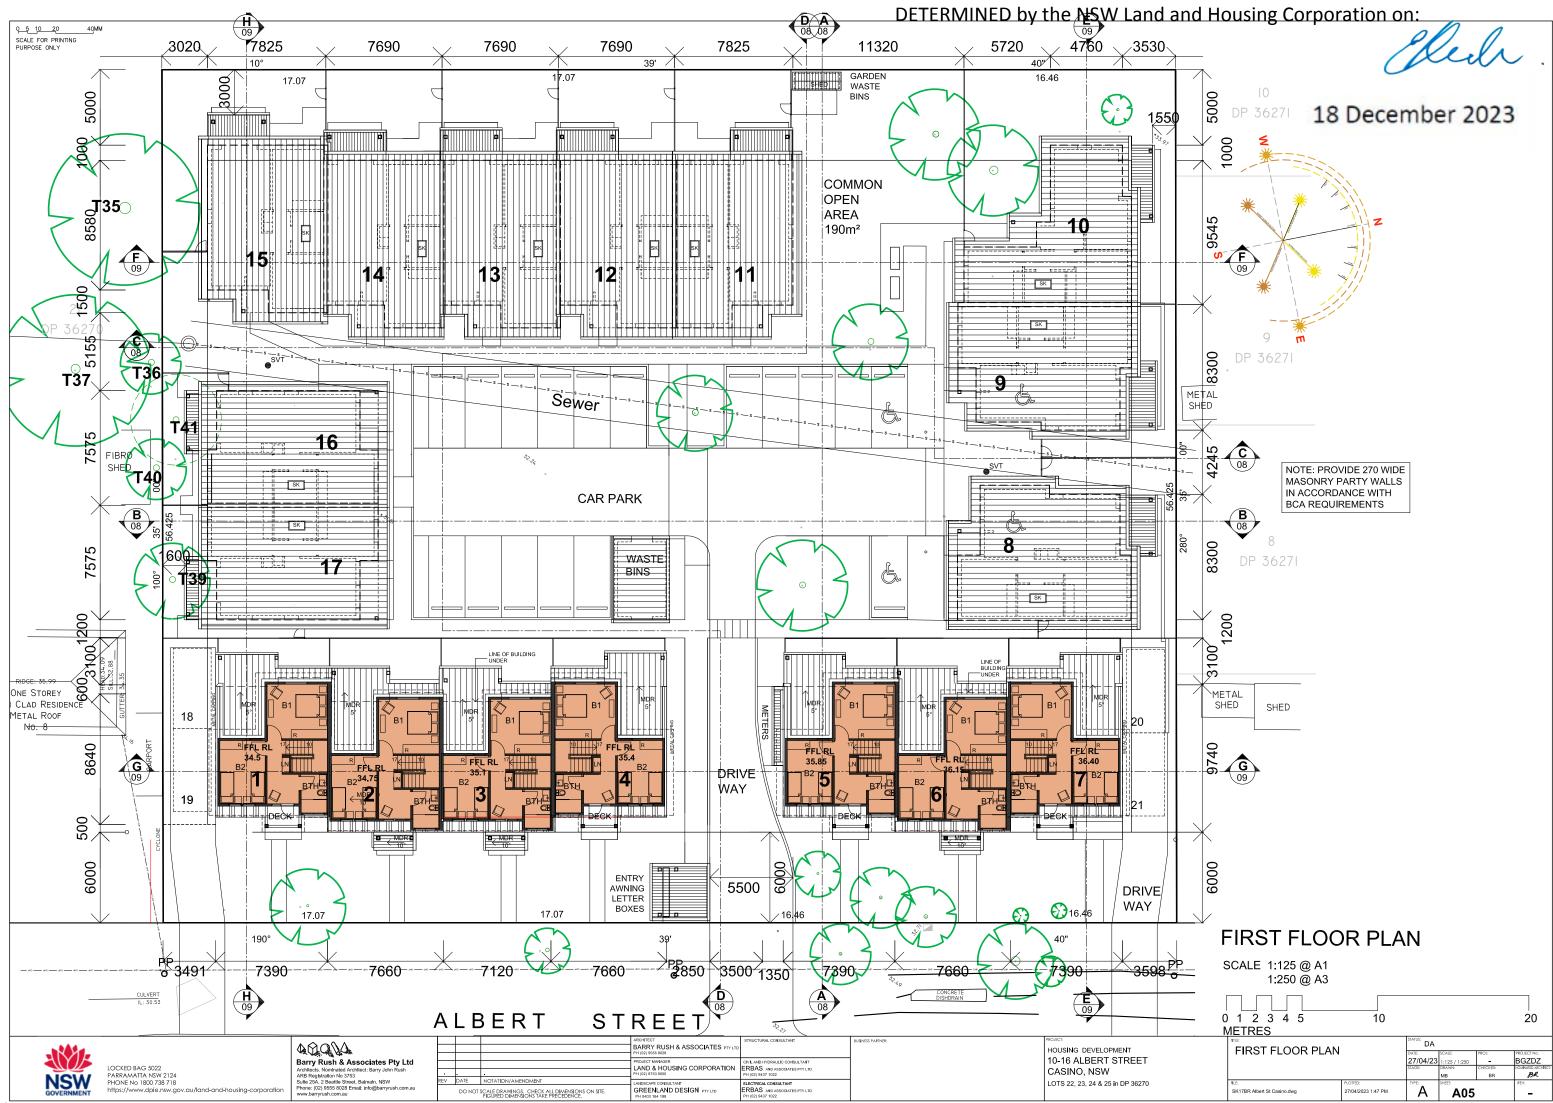








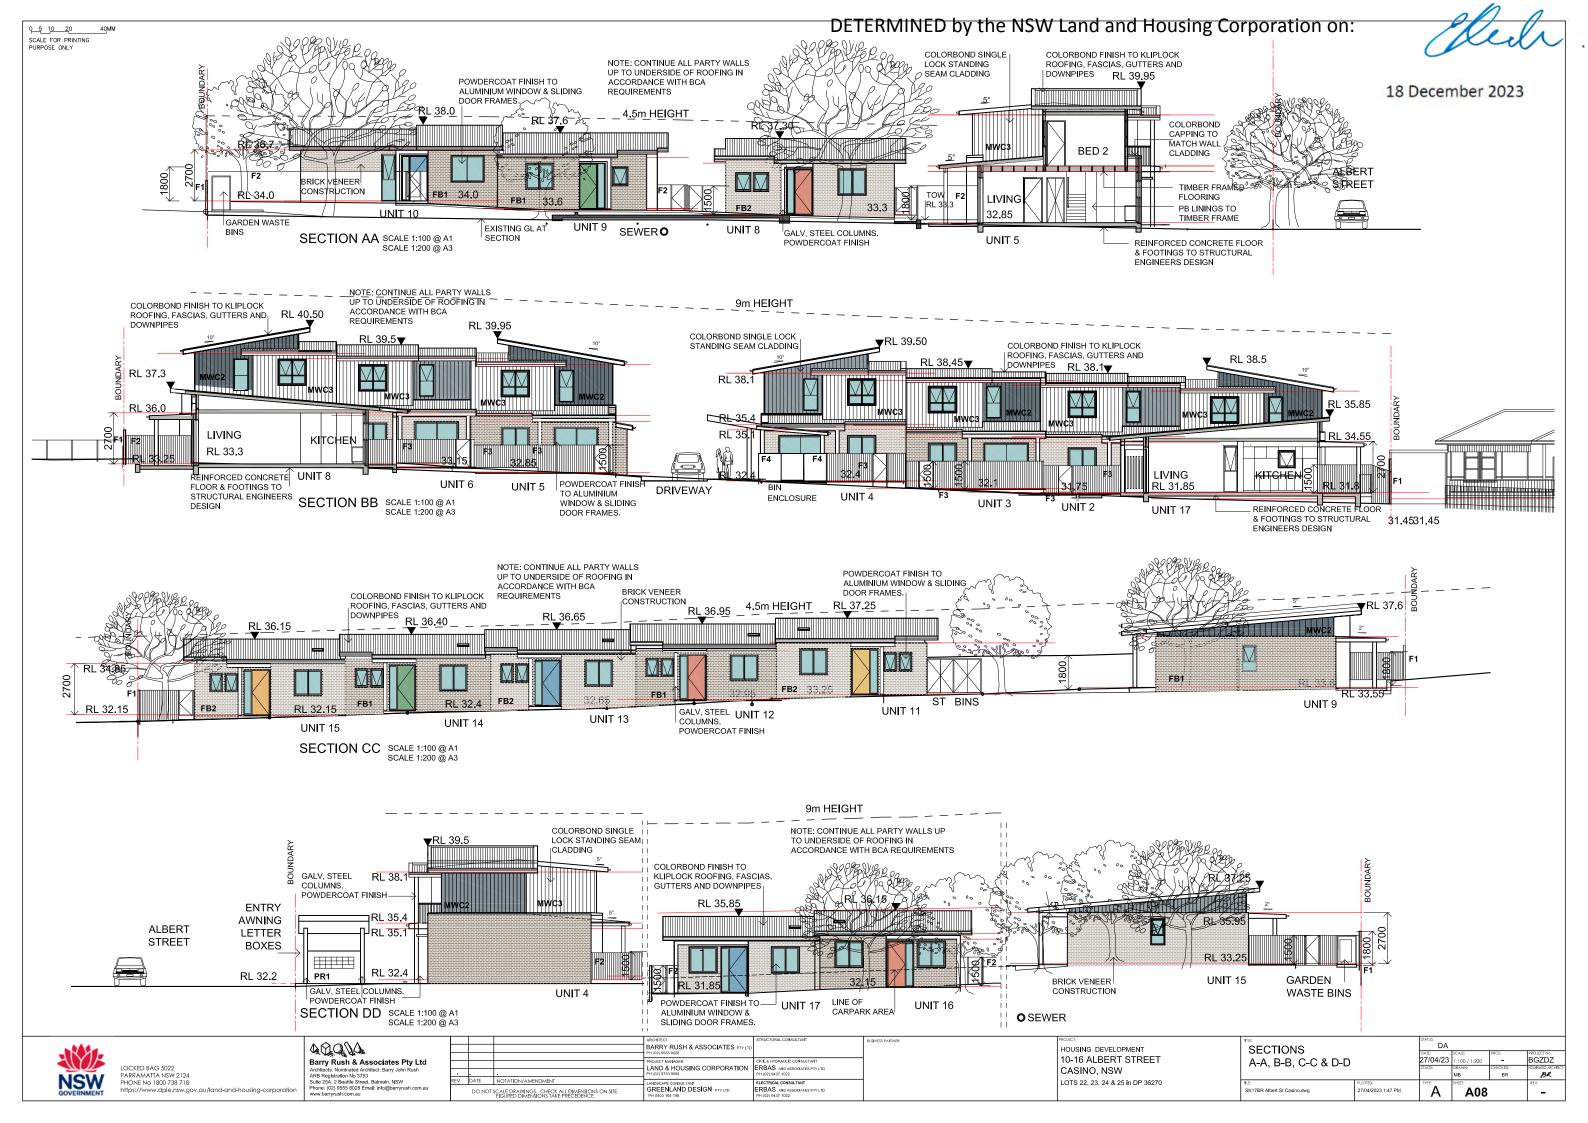

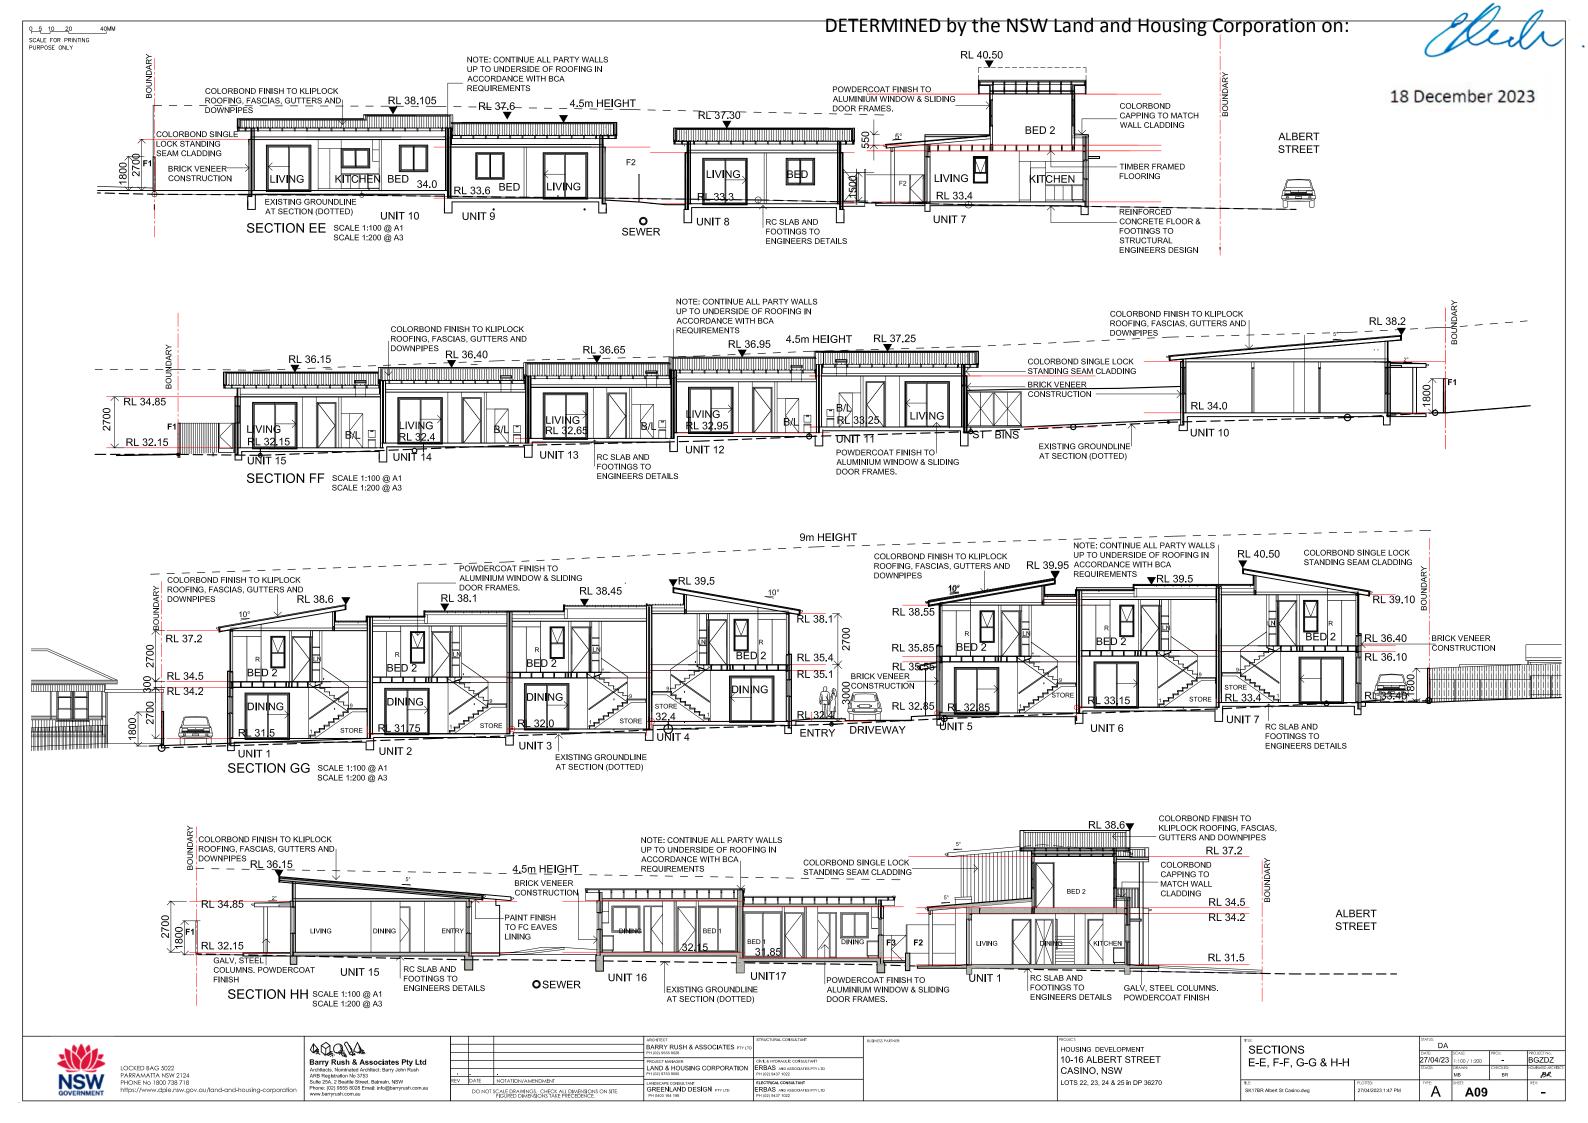

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DETERMINED by the NSW Land and Housing Corporation on:

Unit Number	CFA	UnCFA	Heating Load	Cooling Load	Total Load	Stars
1	89	11	15.6	35.6	51.2	7.1
2	89	11	8.2	31.1	39.3	7.9
3	89	11	5.8	30.4	36.2	8.1
4	89	11	11.2	37.3	48.5	7.2
5	89	11	15.7	35.1	50.8	7.1
6	89	11	6.8	29.9	36.7	8.1
7	89	11	11.5	36.0	47.5	7.3
8	79	0	10.8	22.2	33.0	8.4
9	76	0	4.7	16.3	21.0	9.3
10	68	0	5.9	36.5	42.4	7.7
11	72	0	3.8	26.0	29.8	8.6
12	72	0	3.1	22.1	25.2	8.9
13	72	0	3.4	22.2	25.6	8.9
14	72	0	3.5	21.7	25.2	8.9
15	72	0	9.8	27.4	37.2	8.1
16	70	0	7.8	34.9	42.7	7.7
17	70	0	10.7	24.6	35.3	8.2
					AVG	8.1

	10-16 Albert Street Casino								
SUMMA	RY OF BA	SIX (COM	МІТМЕ	NTS FO	RE	ACH L	JNIT	
This is a summary of the BASIX Commitments as detailed in the BASIX Certificate. Refer to the CURRENT BASIX Certificate for Complete details. For definitions refer to basix.nsw.gov.au									
WATER CO	MMITMENTS	5							
Fixtures									
3 Star Showe	r Heads		Yes (3	> 4.5 but <	6 L/min)				
5 Star Kitche	n / Basin Taps	5	Yes		4 Star Toi	et	Yes		
	ernative Wate	r							
Minimum Tar	nk Size (L)	900	0 0	Collected 1	from Roof	Are	a (m2)	800	
Tank Connec	ted To:								
One Common Outdoor Tap Yes									
One Outdoor	Tap to each u	unit	Yes						
THERMAL C	OMFORT COM	NMITN	NENT	S - Refer f	to TPA Sp	eclfi	cation or	n plans	
ENERGY CO	MMITMENTS								
Hot Water	Electric Heat	Pump	31 to	35 STCs					
Cooling	Living	No	ne						
System	Bedrooms	No	None						
Heating	Living	No	None						
System	Bedrooms	No	None						
	1 x Bathroon	n Fai	Fan ducted to exterior				Manual on/off		
Ventilation	Kitchen	Fai	n ducte	ed to exterio	or		Manual on/off		
	Laundry	Fai	Fan ducted to exterior				Manual on/off		
Natura	Window/Sky	ylight	In Kite	chen		As	As drawn		
Lighting	Window/Sky	ylight	in Bat	throoms/T	oilets	As	drawn		
Artificial	Number of b	oedroc	oms		All	De	dicated	Yes	
Lighting	Number of L	iving/	Dining	rooms	All	Dedicated		Yes	
(rooms to be	Kitchen				Yes	De	dicated	Yes	
primarily lit by fluorescent or	All Bathrms	/Toile	ts		Yes	Dedicated		Yes	
LED lights)	Laundry				Yes	Dedicated		Yes	
CED IIginta)	s			Yes	De	dicated	Yes		
OTHER COM	MITMENTS								
Outdoor cloth	Yes	Yes Ventilated refrigerator space Yes				Yes			
Stove/Oven	Induc	Induction cooktop & electric oven							
Alternative Energy n/a									

DEVELOPMENT DATA

Job Reference	BGZDZ
Locality / Suburb	Casino
Street Address	10-16 Albert Sreet
Lot & DP	Lots 22-25 in DP 36270
Site Area	3784 m ² by title
Existing Lots	4
Proposed GFA	1,501 m²
No. of Dwellings	10 x 2 Bed + 7 x 3 Bed = 17 Dwellings

	Control	Requirement	Proposed
HEIGHT	Richmond Valley Council LEP Housing SEPP	8.5m 9.0m	6.3m to ceiling 7.8m to top of roof
	LRHDG Rear 40% of Site	4.5m	rear 40% of site < 4.5m
FSR	Richmond Valley Coast DCP	0.8:1 (3027.2m ²)	0.37:1 (1,501m²)
LOT SIZE & WIDTH	Richmond Valley Coast DCP	Site 1000 m² Width 20m	Site 3,784m² Width 67m
SETBACKS	Richmond Valley Coast DCP multi - dwelling	Front Setback 6.0m	6.0m MIN
	LRHDG	Side Setback = H - 3m	3-3.4m to buildings 1.6m to side awnings
	LRHDG	Rear Setback = 6m	5-6m Impacted by existing sewer & trees
PARKING	Housing SEPP non -accessible site	1 x(no. 2 Beds) = 10 1.5 x (no. 3 Beds) = 10.5	21 car spaces
BICYCLE PARKING	LRHDG	1 space per Dwelling	Bicycles to be in POS areas
POS Private open space	LAHC Dwelling Requirements	Dwellings at ground floor 15m ²	All POS > 25m ²
	Richmond Valley Coast DCP multi - dwelling	1+2 bed Dwelling = 16m² 3 bed Dwelling = 25m²	All POS > 25m ²
LANDSCAPING	Richmond Valley Coast DCP multi - dwelling	20% of site area = 756 m ²	1,193m²
SOLAR ACCESS	LAHC / ADG Solar Guidelines	3 hrs to 70% of Dwellings in Mid-Winter = 11.9	17 =100%

						SOLAR A	CCESS
DWELLINGS	Number	Type*	Beds	Area* (m ²)	POS*	LIVING	POS
	1	T/H	3	99.0	21	4hr	4 hr
	2	T/H	3	99.0	29	4 hr	4 hr
	3	T/H	3	99.0	20	4 hr	5 hr
	4	T/H	3	99.0	21	6 hr	6 hr
	5	T/H	3	99.0	21	4 hr	5 hr
	6	T/H	3	99.0	29	4 hr	4 hr
	7	T/H	3	99.0	21.4	6 hr	6 hr
	8	VILLA	2	80.2	51	6 hr	6 hr
	9	VILLA	2	79	42	6 hr	6 hr
	10	VILLA	2	70	139	6 hr	6 hr
	11	VILLA	2	72.2	46	4 hr	5 hr
	12	VILLA	2	72.2	46	4 hr	5 hr
	13	VILLA	2	72.2	46	4 hr	5 hr
	14	VILLA	2	72.2	46	4 hr	5 hr
	15	VILLA	2	72.2	76	4 hr	5 hr
	16	VILLA	2	70.1	26	6 hr	2 hr
I	17	VILLA	2	70.1	36	6 hr	2 hr

NSW	


LOCKED BAG 5022 PARRAMATTA NSW 2124	Barry Rush & Associates Pty Ltd Architects. Nomhated Architect: Barry John Rush ABB Registration No 3753
PHONE No 1800 738 718 https://www.dpie.nsw.gov.au/land-and-housing-corporation	Sulte 25A, 2 Beattle Street, Balmain, NSW Phone: (02) 9555 8028 Email: info@barryrush.com.au www.barryrush.com.au

				ARCHITECT BARRY RUSH & ASSOCIATES PTY LTD PH (02) 9555 8028	STRUCTURAL CONSULTANT	BUSINESS PARTNER:	PROJECT: HOUSING DEVELOPMENT
			•	PROJECT MANAGER LAND & HOUSING CORPORATION PH (02) 8753 9000	CIVIL AND HYDRAULIC CONSULTANT ERBAS AND ASSOCIATES PTY LTD PH (02) 9437 1022		10-16 ALBERT STREET CASINO, NSW
R	REV DATE NOTATION/AMENDMENT DO NOT SCALE DRAWINGS. CHECK ALL DIMENSIONS ON SITE. FIGURED DIMENSIONS TAKE PRECEDENCE.			LANDSCAPE CONSULTANT GREENLAND DESIGN PTY LTD PH 0403 164 198	ELECTRICAL CONSULTANT ERBAS AND ASSOCIATES PTY LTD PH (02) 9437 1022		LOTS 22, 23, 24 & 25 in DP 36270

	18 Decemb	oer 2023		Ke	ilr
May 2023				Reference: 19506	
	nability Assessments			(02) 4962 3439	
enquirles@build	lingsustainability.net.au	www.	bulldingsusta	inability.net.au	
the Assessor Cert Assessor and Nati BCA provisions fo In NSW both BASI) - Thermal construi - Thermal breaks i - Floor insulation f - Building sealing	Important ification was used to achieve ificate. If the proposed consts IERS certificates will no long r building sealing & ventilatio & the BCA variations must be tion in accordance with Vol or Class 1 dwellings as per F in accordance with Section J	e the thermal ruction varies ger be valid. n are compli complied wit 1 Section J1. rdance with F Part 3.12.1.5 3 or Part 3.1	to those detailed Assessments as ed with at constru- h, in particular the 2 or Vol 2 Part 3 Part 3.12.1.2(c) & a)(ii), (iii) & (e) or 2.3.1 to 3.12.3.6.	d below than the sume that the iction. following: .12.1.1 3.12.1.4(d) • (c), (d) & (e)	
	nal Performance Specificat	ions (does r			
External Wall Co				Added Insulation	1
Brick Veneer & L	igntweight			R2.0	1
Internal Wall Cor	atrustion			Added Insulation	
Plasterboard on s				Added Insulation None	
Cavity Brick (Parl				None	
Ceiling Construc	, ,			Added Insulation	
Plasterboard	uon -	R3 5	to ceilings adjac		
Roof Constructio	n Colour (Solar Absorpt			Added Insulation	
Meta	Basalt (SA			i + R1.0 blanket	
Floor Construction	n Covering			Added Insulation	
Concrete As o	lrawn (if not noted default val	ues used)		None	
Timber As o	Irawn (if not noted default val	ues used)		None	
Windows Gla	ss and frame type	U value	SHGC Range	Area sq m	1
ALM-001-03 A A	uminium Type A Single Low	не 5.40	0.44 - 0.54	Unit 1 & 5 Only	1
	luminium Type B Single Low		0.52 - 0.64	Unit 1 & 5 Only	1
	luminium Type A Single clea		0.51 - 0.63	All other units	1
	luminium Type B Single clea		0.63 - 0.77	All other units	1
	awning windows, bifolds, caseme double hung windows, sliding wir				
Skylights Gla	ss and frame type U	SHGC Are	a sq m	Detail	1
Single glazed as	Irawn	-			1
U and SHGC values SHGC is within the r	are according to AFRC. Alternati ange specified	e products ma	y be used if the U v	alue is lower & the	
Shade elements All shade element	s modelled as drawn		(eaves, verand	lahs, awnings etc)	
Celling Penetration	ons	(0	lownlights, exhau	ist fans, flues etc)	1
Modeled as draw	n and/or to comply with the v	entilation and	d sealing requirer	nents of the BCA	1
Ducting is modelle	d at 150mm. No insulation l	osses from d	ownlighting have	been modelled	1

•

	DEVELOPMENT DATA			STATUS: DA				
						PROJECT No.		
			27/04/23	NTS		BGZDZ		
			STAGE:	DRAWN:	CHECKED:	NOMINATED ARCHITECT:		
				MB	BR	BR		
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EAST ELEVATION (FACING ALBERT STREET)

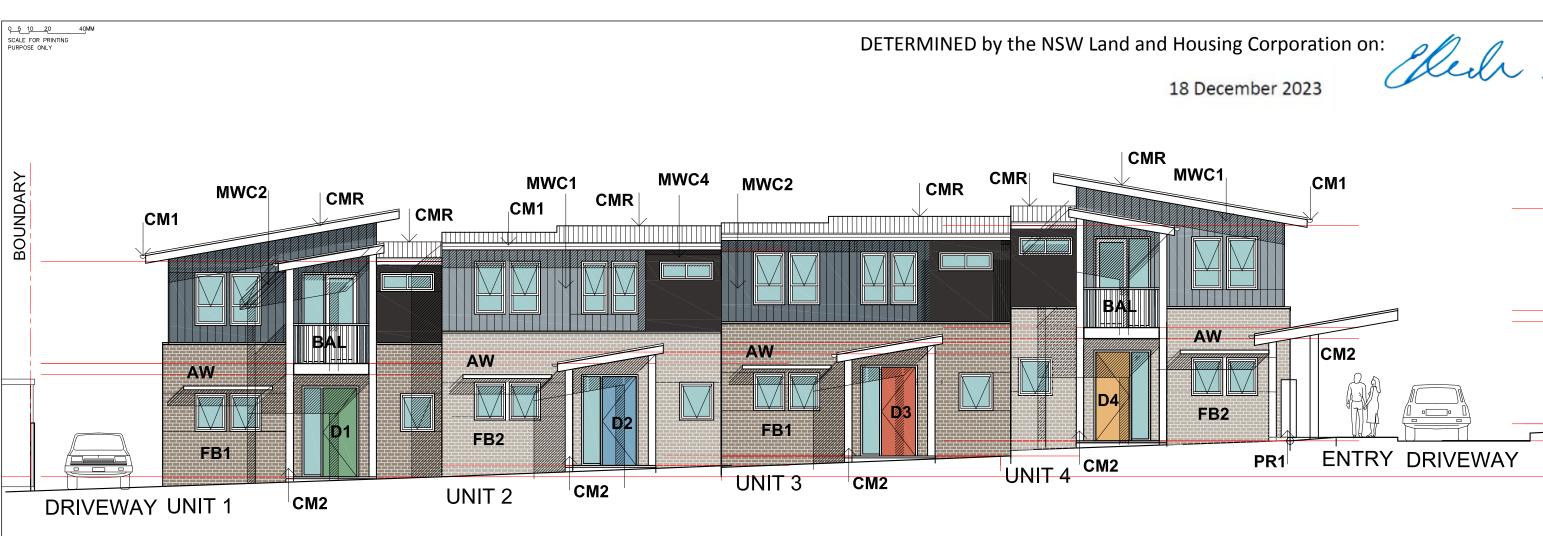FINISHES SCHEDULE

CODE	LOCATION	DESCRIPTION	COLOUR
CMR	ROOFING/ FLASHINGS, CAPPINGS, BARGES, FASCIA	KLIP-LOK HI-STRENGTH COLORBOND STEEL	COLORBOND "BASALT"
CM1	GUTTER, DOWNPIPES	METAL COLORBOND & GALV STEEL	COLORBOND "WINDSPRAY"
CM2	METAL STRUCTURE, BEAMS, COLUMNS TO ENTRY'S & REAR AWNINGS	METAL POWDERCOAT TO GALV STEEL	COLORBOND "SURFMIST"
MWC1	FIRST FLOOR METAL WALL CLADDING	COLORBOND SINGLE LOCK STANDING SEAM CLADDING 325mm WIDE	COLORBOND "BASALT"
MWC2	FIRST FLOOR METAL WALL CLADDING	COLORBOND SINGLE LOCK STANDING SEAM CLADDING 325mm WIDE	COLORBOND "MONUMENT"
MWC3	FIRST FLOOR METAL WALL CLADDING	COLORBOND SINGLE LOCK STANDING SEAM CLADDING 325mm WIDE	COLORBOND "DUNE"
MWC4	METAL WALL CLADDING	COLORBOND STEEL "MINI ORB" VERTICAL	COLORBOND "NIGHT SKY"

CODE	LOCATION	DESCRIPTION	COLOUR
FB1	GROUND FLOOR WALLS UNITS 1,3,5,7,9,10,12,14,16	FACE BRICK PGH WIRE CUT	MINERAL VELOUR
FB2	GROUND FLOOR WALLS UNITS 2,4,6,8,11,13,15,17	FACE BRICK PGH WIRE CUT	CRUSHED GREY PURE VELVET
FB3	RETAINING WALLS	FACE BRICK PGH WIRE CUT	VOLCANIC VELOUR
PR1	LETTERBOX WALL	PAINTED RENDER TO BRICK WALL	DULUX BASALT
LB	LETTERBOXES RECESSED INTO WALL	POLISHED ALUMINIUM	NATURAL
BAL	FIRST FLOOR BALCONY BALUSTRADES	POWDERCOAT TO GALVANIZED STEEL	DULUX BASALT
AW	WINDOW AWNINGS	POWDERCOAT TO GALVANIZED STEEL	COLORBOND "BASALT"

CODE	LOCATION	DESCRIPTION	COLOUR
F1	METAL FENCES TO SITE BOUNDARIES	1800 HIGH (UNLESS NOTED OTHERWISE) COLORBOND METAL FENCE	COLORBOND WALLABY
F2	SLATTED METAL FENCES TO POS AREAS	1500 HIGH (UNLESS NOTED OTHERWISE) COLORBOND METAL FENCE	COLORBOND WINDSPRAY
F3	VERTICAL SLATTED METAL FENCES TO REAR POS FACING CENTRAL COURTYARD	1500 HIGH (UNLESS NOTED OTHERWISE) POWDERCOAT STEEL METAL FENCE TO DETAIL	DULUX WINDSPRAY
F4	METAL FENCES TO WASTE BIN AREA	1500 HIGH POWDERCOAT STEEL METAL FENCE TO DETAIL	DULUX MONUMENT
WD	WINDOWS & DOOR FRAMING	POWDERCOATED ALUMINIUM	DULUX MONUMENT
D1	FRONT DOOR UNITS 1,5,9,13,17	PAINT TO EXT. SOLID CORE DOOR	WATTYL "PEE POD"
D2	FRONT DOOR UNITS 2,6,10,14	PAINT TO EXT. SOLID CORE DOOR	WATTYL "DUCK BLUE"
D3	FRONT DOOR UNITS 3,7,11,15	PAINT TO EXT. SOLID CORE DOOR	WATTYL "ORANGE"
D4	FRONT DOOR UNITS 4,8,12,16	PAINT TO EXT. SOLID CORE DOOR	WATTYL "MANGO"

HOUSING DEVELOPMENT 10-16 ALBERT STREET CASINO, NSW LOTS 22, 23, 24 & 25 in DP 36270

					BARRY RUSH & ASSOCIATES PTYLTD PH (02) 9555 8028		BUSINESS PARTNER:
	LOCKED BAG 5022 PARRAMATTA NSW 2124	Barry Rush & Associates Pty Ltd Architects. Nominated Architect: Barry John Rush ARB Registration No 3753			PROJECT MANAGER LAND & HOUSING CORPORATION PH (02) 8753 9000	CIVE AND HYDRAULIC CONSULTANT ERBAS AND ASSOCIATES PTY LTD PH (02) 9437 1022	
	PHONE No 1800 738 718 https://www.dpie.nsw.gov.au/land-and-housing-corporation	Sulte 25A, 2 Beattle Street, Balmain, NSW R Phone: (02) 9555 8028 Email: info@barryrush.com.au www.barryrush.com.au	REV		LANDSCAPE CONSULTANT GREENLAND DESIGN PTY LTD PH 0403 164 198	ELECTRICAL CONSULTANT ERBAS AND ASSOCIATES PTY LTD PH (02) 9437 1022	



		STATUS: DA				
	EXTERNAL COLOUR & FINISHES SCHEDULE			SCALE: NTS		PROJECT No. BGZDZ
				DRAWN: MB	CHECKED: BR	NOMINATED ARCHITECT:
	HLE: SK17BR Albert St Casino.dwg	PLOTTED: 27/04/2023 1:47 PM		SHEET: A11		REV:

9 - 15 DEAN STREET

EXISTING 1 STOREY TOWNHOUSE DEVELOPMENT



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 $A \bigcirc O \bigcirc A$ Barry Rush & Associates Pty Ltd Architects. Nominated Architect: Barry John Rush ARB Registration No 3753 Suite 25A, 2 Beattie Street, Balmain, NSW Phone: (02) 9555 8028 Email: info@barryrush.com.au www.barryrush.com.au


REV	DATE	NOTATION/AMENDMENT
	DO NOT	SCALE DRAWINGS. CHECK ALL DIMENSIONS FIGURED DIMENSIONS TAKE PRECEDENCE.




PROPOSED 1 & 2 STOREY TOWNHOUSE DEVELOPMENT 10 - 16 ALBERT STREET




EXISTING DEVELOPMENT (WITH IMAGE)

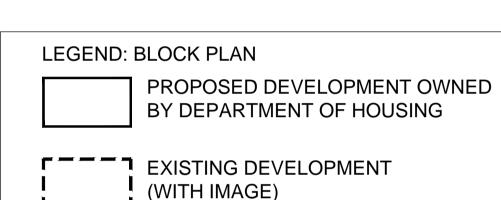

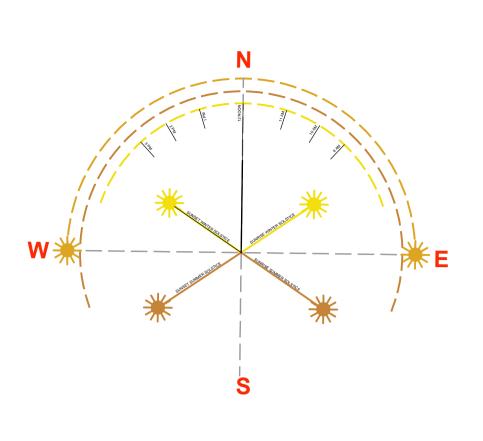

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	ARCHITECT	STRUCTURAL CONSULTANT
	BARRY RUSH & ASSOCIATES PTY LTD PH (02) 9555 8028	
	111(02) 5555 5625	
	PROJECT MANAGER	CIVIL AND HYDRAULIC CONSULTANT ERBAS AND ASSOCIATES PTY LTD
	PH (02) 8753 9000	PH (02) 9437 1022
	LANDSCAPE CONSULTANT	ELECTRICAL CONSULTANT
IS ON SITE.		ERBAS AND ASSOCIATES PTY LTD PH (02) 9437 1022

BUSINESS PARTNER:

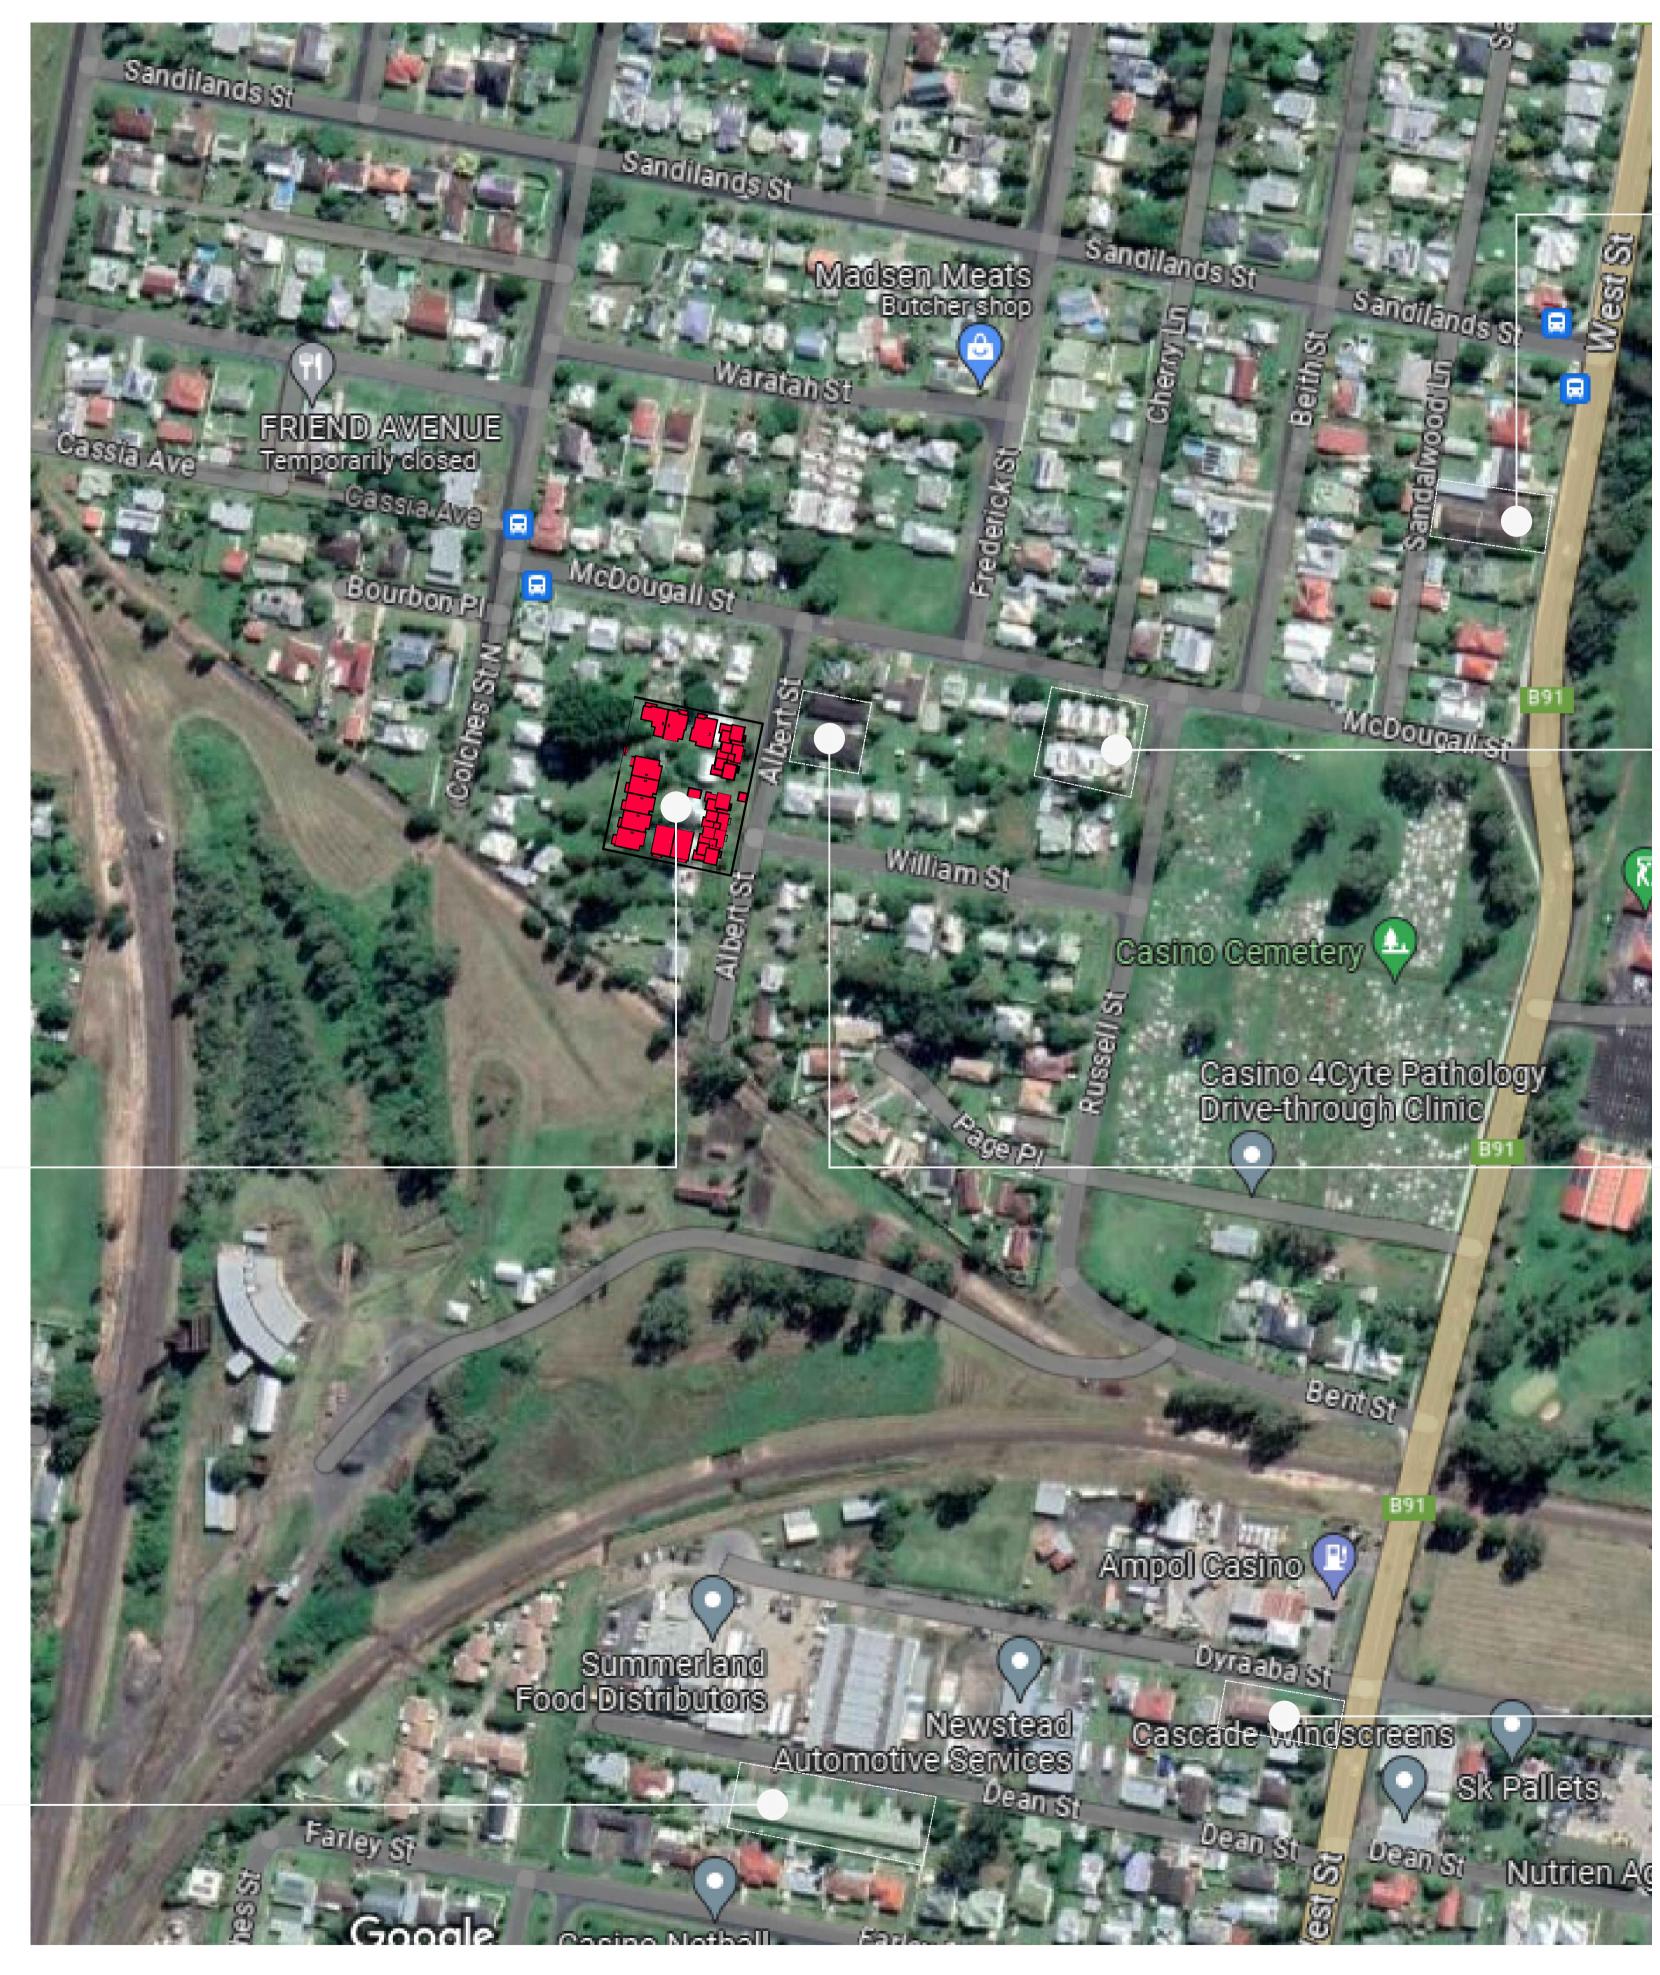HOUSING DEVELOPMENT 10-16 ALBERT STREET CASINO, NSW LOTS 22, 23, 24 & 25 in DP 36270 18 December 2023



EXISTING 2 STOREY UNIT DEVELOPMENT 156 WEST STREET





Kein

EXISTING 1 & 2 STOREY TOWNHOUSE DEVELOPMENT CNR RUSSELL & McDOUGALL STREETS



EXISTING 1 STOREY VILLA DEVELOPMENT 13 ALBERT STREET




EXISTING 2 STOREY UNIT DEVELOPMENT 35 DYRAABA STREET

	STATUS: DA				
BLUCK ANAL 1515 F				PROJECT No.	
	27/04/23	NTS	-	BGZDZ	
	stage:	DRAWN:	CHECKED:	NOMINATED ARCHITECT:	
			LP	BR	BR
FILE:	PLOTTED:	TYPE:	SHEET:		REV:
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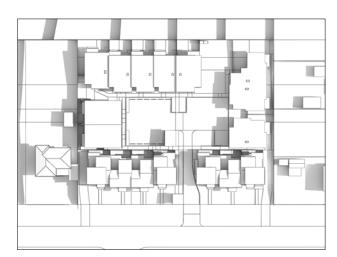
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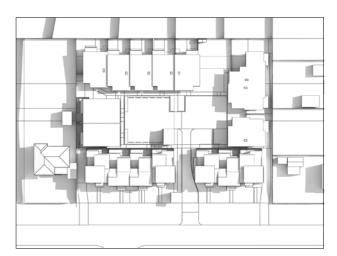
9AM 21ST JUNE




10AM 21ST JUNE

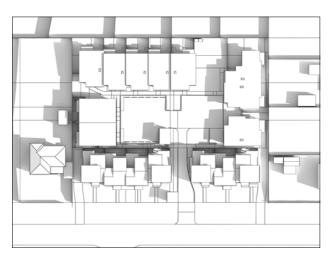

11AM 21ST JUNE



12NOON 21ST JUNE

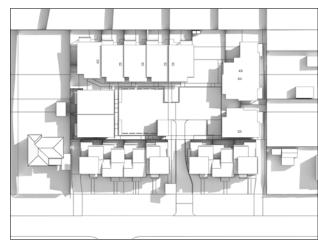

LEGEND:

CIVIL AND HYDRAULIC CONSULTANT RBAS AND ASSOCIATES PTY LTD

ELECTRICAL CONSULTANT ERBAS AND ASSOCIATE





2PM 21ST JUNE



3PM 21ST JUNE



LOCKED BAG 5022 PARRAMATA NSW 2124 PHORE No 1800 738 718 https://www.dpie.nsw.gov.au/land-and-housing-corp

Barry Rush & Associates Pty Ltd Architects. Nominated Architect: Barry John Rush Architects. Nomhated Architect: Barry John Rush ARB Registration No 3753 Suite 25A, 2 Beattle Street, Bajmain, NSW Phone: (02) 9555 8028 Email: info@barryrush.com.au www.barryrush.com.au

DATE NO

DO NOT SCALE DRAWINGS. CHECK ALL DIMENSIONS ON SITE. FIGURED DIMENSIONS TAKE PRECEDENCE.



Grey area indicates shadows cast by proposed development

NORTH

BARRY RUSH & ASSOCIATES PT

LAND & HOUSING CORPORATION

GREENLAND DESIGN PTY LTD





	-	STATUS: DA				
	DATE: 27/04/23					
MID WINTER	STAGE:			NOMINATED ARCHITECT:		
			LP	BR	BR	
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DA11 - 16 Albert St Casino.dwg	10/05/2023 12:17 PM	Α	A13		-	

0 5 10 20 40MM SCALE FOR PRINTING PURPOSE ONLY


DETERMINED by the NSW Land and Housing Corporation on:






10AM 21ST JUNE

11AM 21ST JUNE

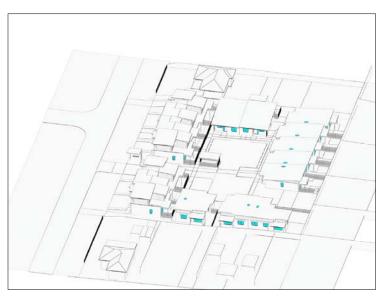

12NOON 21ST JUNE

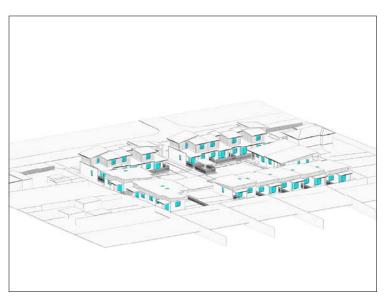


3PM 21ST JUNE



	AQQ\A
	Barry Rush & Ass
	Architects. Nominated Archit ARB Registration No 3753
and-and-housing-corporation	Suite 25A, 2 Beattie Street, I Phone: (02) 9555 8028 Ema
and and nooting corporation	www.barryrush.com.au

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1PM 21ST JUNE

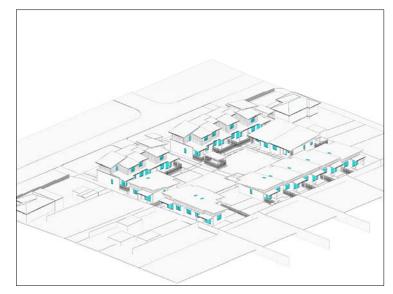2PM 21ST JUNE

	460 JA			ARCHITECT BARRY RUSH & ASSOCIATES PTY LTD PH (02) 9555 8028		BUSINESS PARTNER:	PROJECT: HOUSING DEVELOPMENT
	Barry Rush & Associates Pty Ltd Architects. Nominated Architect: Barry John Rush ARB Registration No 3753			PROJECT MANAGER LAND & HOUSING CORPORATION PH (02) 8753 9000	PH (02) 9437 1022		10-16 ALBERT STREET CASINO, NSW
Suite 25A, 2 Beatte Street, Balmain, NSW Phone: (02) 9555 8028 Email: info@barryrush.com.au www.barryrush.com.au	REV	NOTATION/AMENDMENT SCALE DRAWINGS, CHECK ALL DIMENSIONS ON SITE. FIGURED DIMENSIONS TAKE PRECEDENCE.	GREENLAND DESIGN PTYLTD	ELECTRICAL CONSULTANT ERBAS AND ASSOCIATES PTY LTD PH (02) 9437 1022		LOTS 22, 23, 24 & 25 in DP 36270	



VIEWS FROM SUN -	STATUS: DA				
			SCALE: NTS		PROJECT No. BGZDZ
		STAGE:	DRAWN:	CHECKED:	NOMINATED ARCHITECT:
			LP	BR	BR
ALE:	PLOTTED:	TYPE:	SHEET:		REV:
DA11 - 16 Albert St Casino.dwg	10/05/2023 12:17 PM	A	A14		-



STREET PERSPECTIVE




	Barry Rush & Associates Pty Architects. Nominated Architect: Barry John Ru ARB Registration No 3733 Suite 25A, 2 Beatis Street, Balmain, NSW
au/land-and-housing-corporation	Phone: (02) 9555 8028 Email: info@barryrush. www.barryrush.com.au

				BARRY RUSH & ASSOCIATES PTY LTD PH (02) 9555 8028	
Pty Ltd In Rush				PROJECT MANAGER LAND & HOUSING CORPORATION PH (02) 8753 9000	CIVIL AND HYDRAULIC CONSULTANT ERBAS AND ASSOCIATES PTY LTD PH 1021 9437 1022
/	REV	DATE	NOTATION/AMENDMENT	LANDSCAPE CONSULTANT	ELECTRICAL CONSULTANT
rush.com.au	DO NOT SCALE DRAWINGS. CHECK ALL DIMENSIONS ON SITE. FIGURED DIMENSIONS TAKE PRECEDENCE.			GREENLAND DESIGN PTY LTD PH 0403 164 198	ERBAS AND ASSOCIATES PTY LTD PH (02) 9437 1022

HOUSING DEVELOPMENT 10-16 ALBERT STREET CASINO, NSW LOTS 22, 23, 24 & 25 in DP 36270



	STREET PERSPECTIVE			STATUS: DA				
				SCALE: NTS	PROJ:	PROJECT No. BGZDZ		
	3			DRAWN:		NOMINATED ARCHITECT:		
				LP	BR	BR		
	FILE:	PLOTTED:	TYPE:	SHEET:		REV:		
	DA11 - 16 Albert St Casino.dwg	10/05/2023 12:17 PM	A	A15		-		

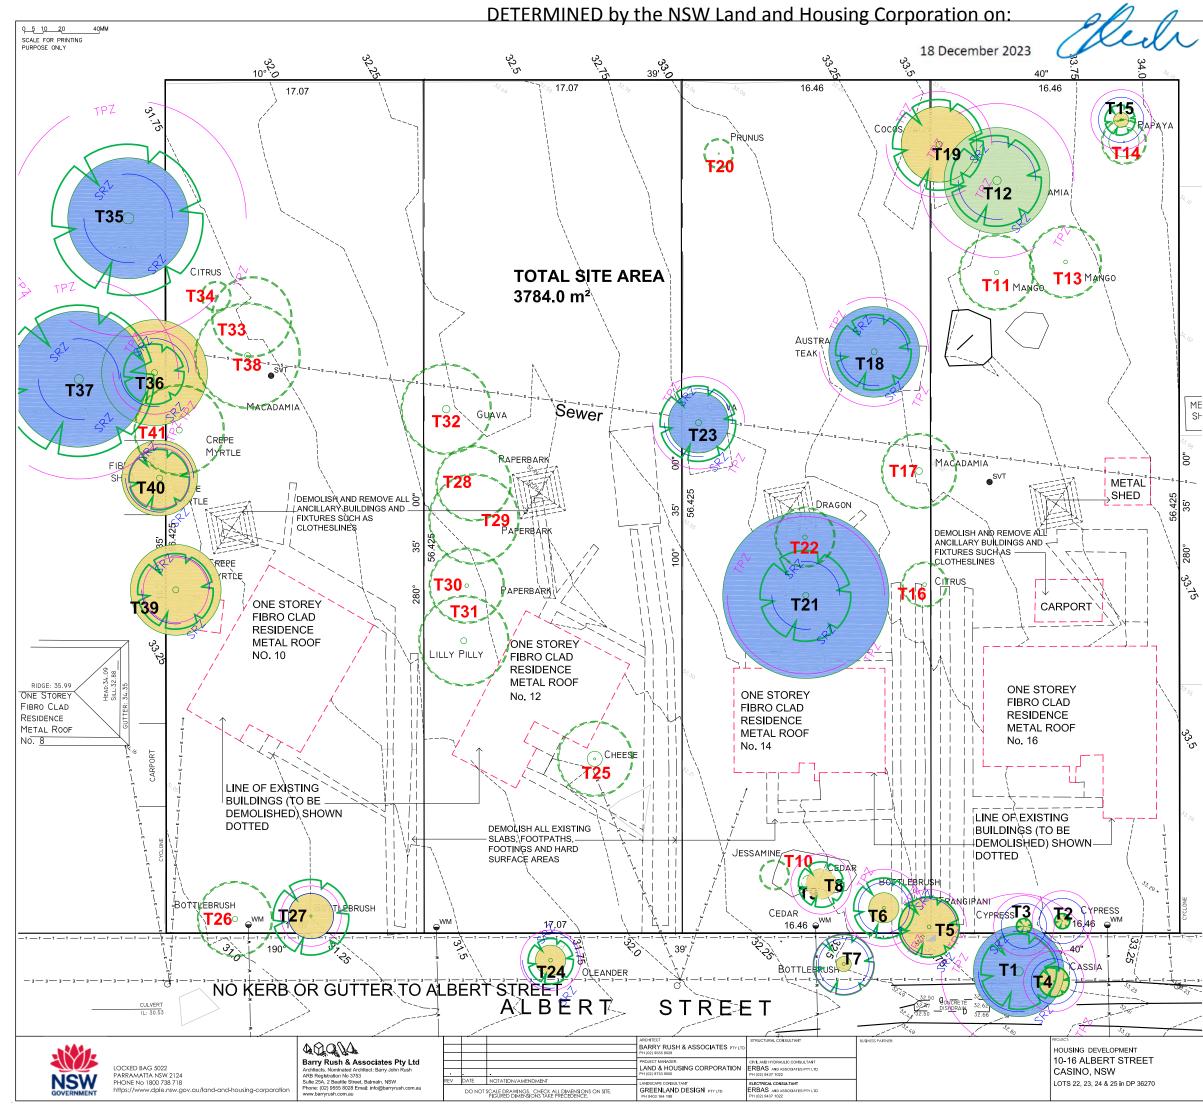

DEMOLITION NOTES:

1. ALL DEMOLITION TO AUSTRALIAN STANDARD AS2601-2001 DEMOLITION OF STRUCTURES

2. DEMOLISH ALL EXISTING DWELLINGS, SHEDS, CARPORTS, GARAGES, STEPS, RAMPS, RETAINING WALLS, SLABS, FOOTPATHS & FOOTINGS, HARD SURFACE AREAS, FENCES, RAILINGS, PLANTER BOXES, TURF, LETTERBOXES, BBQs, CLOTHES HOISTS, AC UNITS, HOT WATER UNITS & METER BOARDS & REMOVE FROM SITE.

3. SORT MATERIALS FOR POTENTIAL TO RECYCLE OR RE-USE ON-SITE

4. DISCONNECT AND REMOVE EXISTING SERVICE LINES AS REQUIRED

5. REMOVE EXISTING TREES & SHRUBS ON SITE INCLUDING STUMP GRINDING & GRUBBING (SHOWN DASHED).

6. ASBESTOS IS TO BE REMOVED FROM EXISTING DWELLINGS PRIOR TO DEMOLITION COMMENCEMENT. A CERTIFICATE IS TO BE SUBMITTED BY A HYGIENIST CONFIRMING THAT ALL ASBESTOS HAS BEEN REMOVED PRIOR TO DEMOLITION, ANOTHER CERTIFICATE IS TO BE SUBMITTED ON COMPLETION OF DEMOLITION

7. REMOVE AND MAKE GOOD TO REDUNDANT DRIVEWAYS AND CROSSOVERS, REPLACE WITH KERB AND GUTTER, MAKE GOOD TO KERB AND GUTTER WHERE REQUIRED.

8. REMOVAL OF ANY SURFACE BUILDING DEBRIS LEFT BEHIND BY DEMOLITION CONTRACTOR IS TO BE REMOVED, THIS INCLUDES CONCRETE, MASONRY AND ASBESTOS PARTICLES.

T35

TREE NUMBER. REFER TO ARBORIST REPORT

T38

TREE TO BE REMOVED

Ku

T23 REFER ARBORIST REPORT

DEMOLITION PLAN


SCALE 1:125 @ A1 1:250 @ A3

0 1 2 3 4 5 METRES

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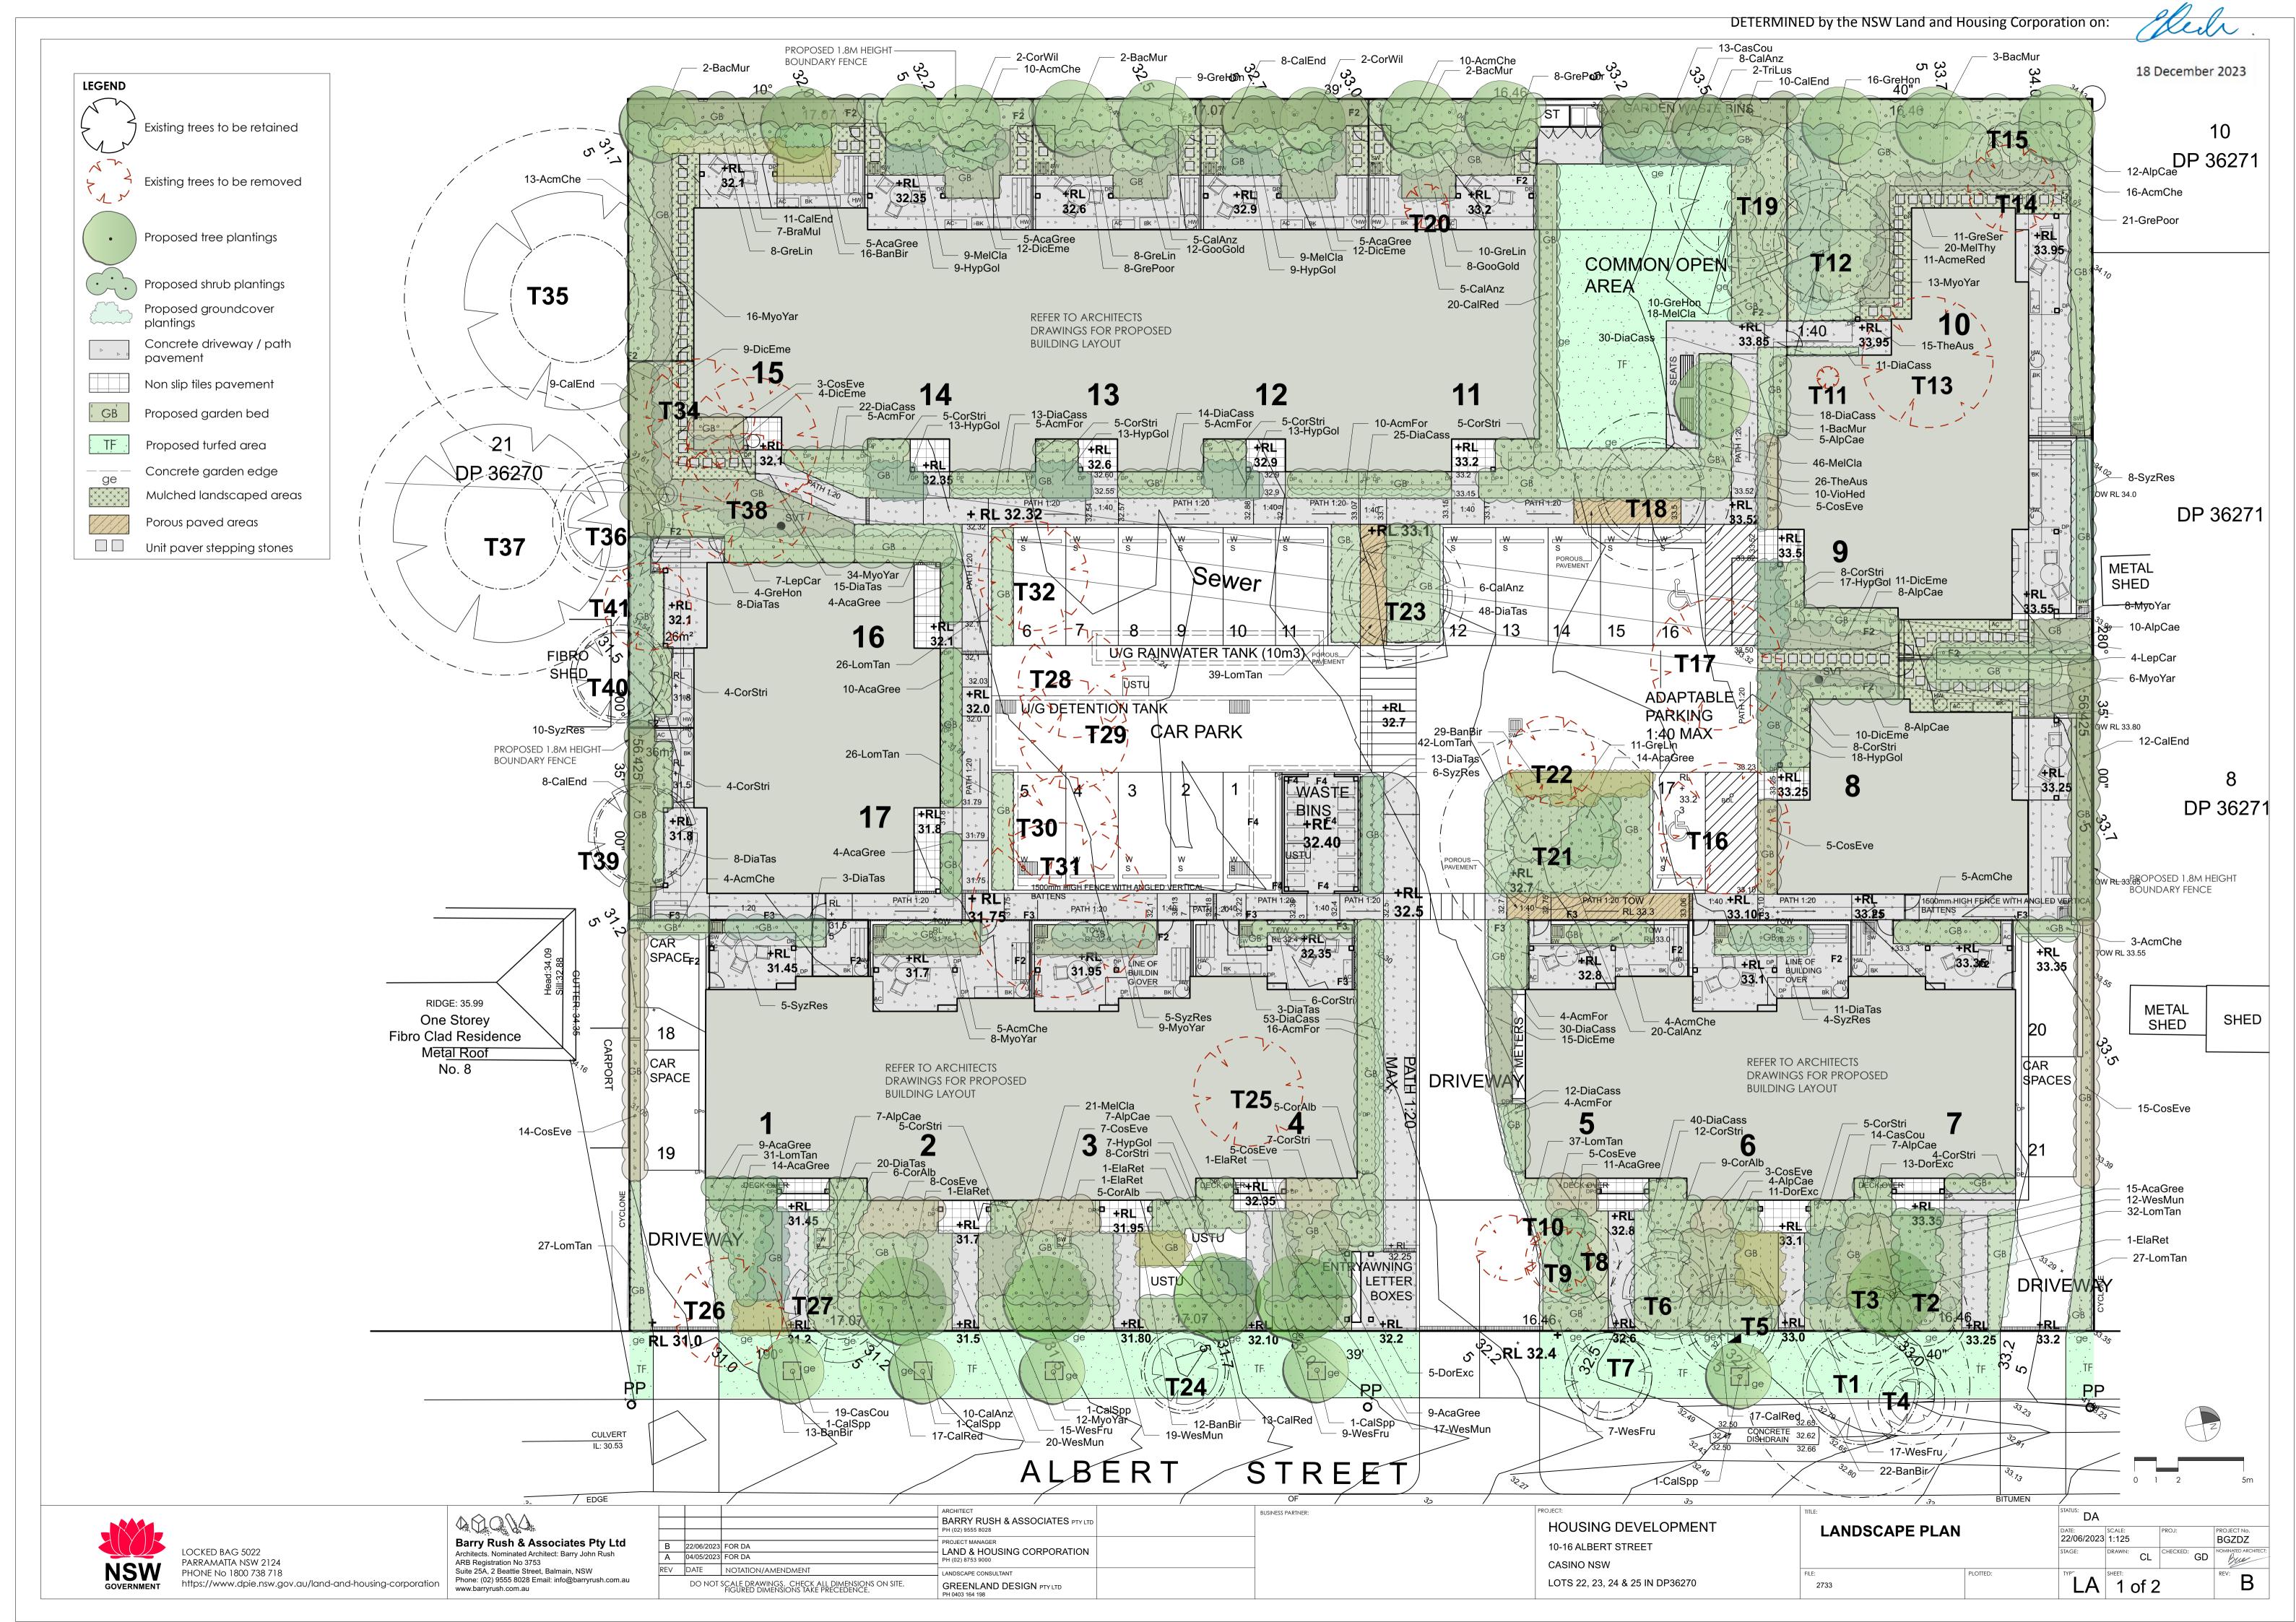
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SCALE 1:125 @ A1 1:250 @ A3		
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		LP	BR	BR	
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-75 LITRE TREE -2x38x38x1800 mm 1000

HARDWOOD STAKES 2 NO. NYLON TIES TWISTED ONCE, STAPLED to stake INSTALL 75mm DEPTH MULCH TO 1000mm radius ADJOINING SURFACE REFER PLANS USE SHOVEL TO TRIM ROOT BALL TO 20mm APPROX. TO ENCOURAGE PLANT GROWTH PLANTING MIX - FERTILISER - RIP BASE TO 150mm DEPTH

NOTE: TREE PITS SHALL NOT BE DUG BY AUGER

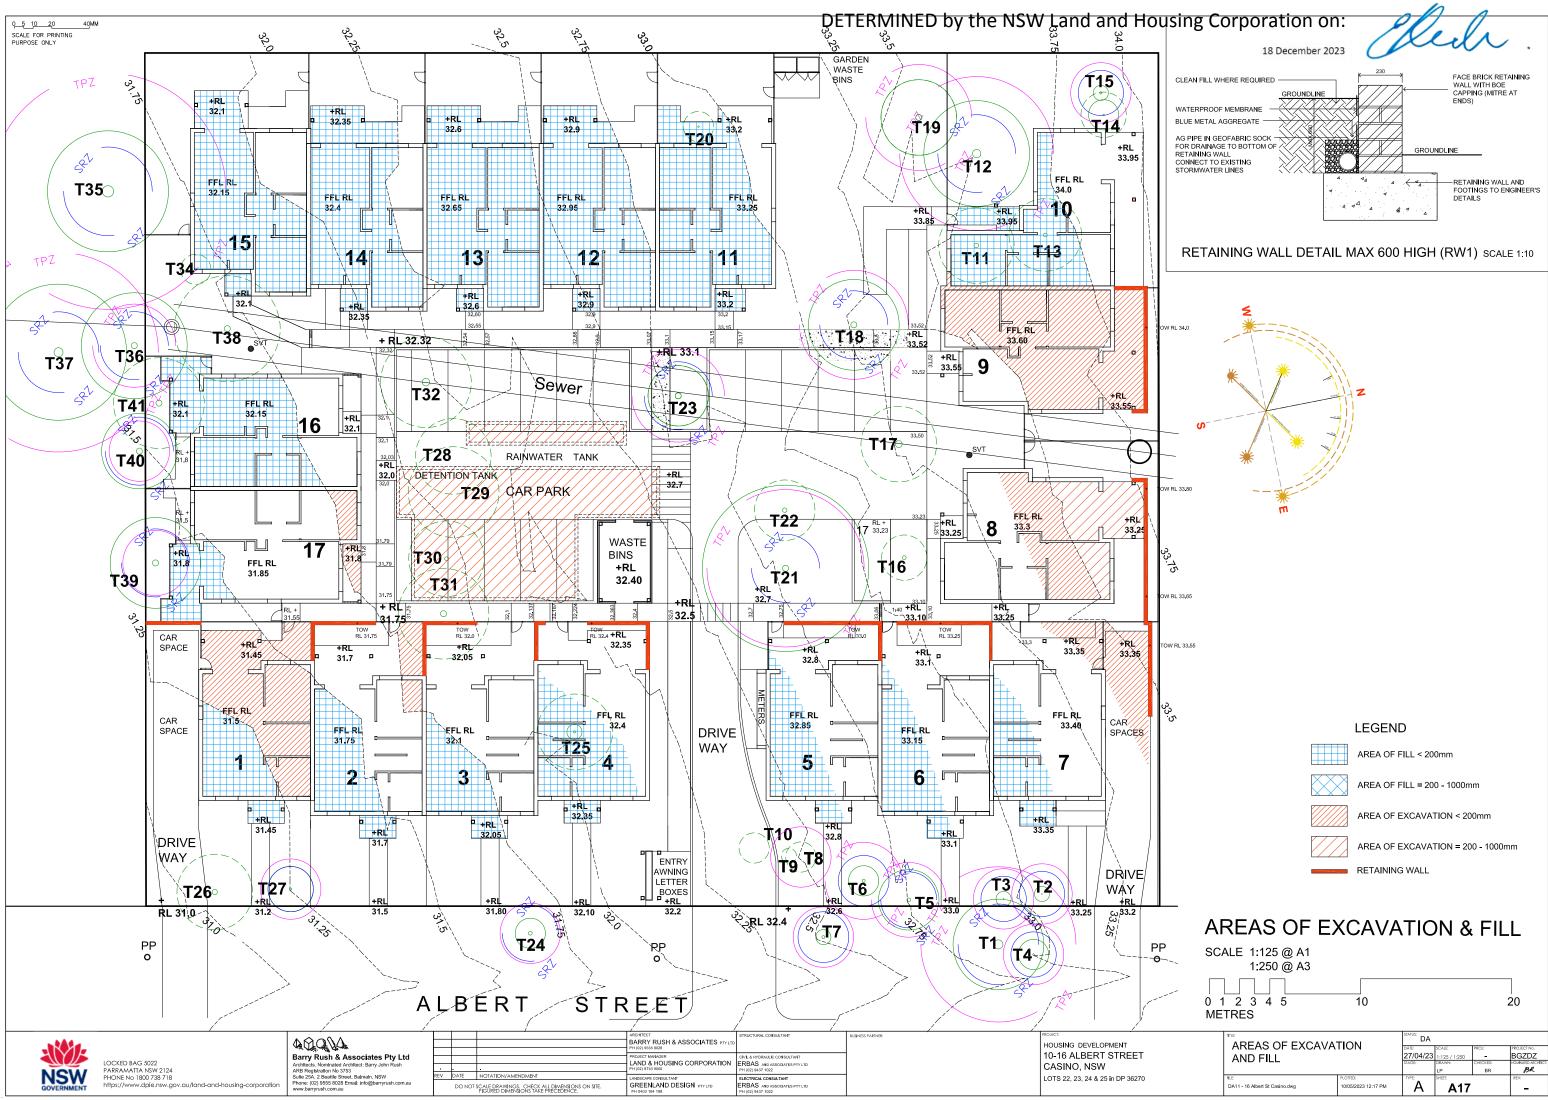75 Litre Tree Planting scale 1:25

SPECIFICATION NOTES

PLANTING MATERIALS

Planting Mix: Planting mix for tree pit backfill shall be "Organic Garden Mix" consisting of

- 50% Black Soil 20% Coarse Sand
- 30% Organic Material

as available from Australian Native Landscapes, Phone: [02] 9450 1444, or approved equivalent. Samples shall be provided to the Superintendent prior to ordering or delivery to site. Any material delivered to site, that is rejected by the Superintendent, shall be removed by the contractor at his own expense. Minimum depths of mix to all planting bed areas is as specified on details.

Mulch: Mulch to garden bed:

Mulch shall mean hardwood mulch (25mm grade), free from material derived from Privet, Willow, Poplar, Coral trees, or other noxious weeds. Any mulch exceeding the 25mm grade shall be rejected / removed from the site. Graded hardwood mulch to be supplied by Australian Native Landscapes Pty Ltd Phone (02) 9450 1444, or approved equivalent.

Spread mulch so that after settling, it is:

• smooth and evenly graded between design surface levels;

• flush with adjacent finished levels:


• of the required depths (75mm); and • sloped towards the base of plant stems in plantation beds, but not in contact

with the stem (not closer than 50mm in the case of gravel mulches). Place after the preparation of the planting bed, planting and all other work.

Plant Material:

All plant material must be true to the species. No substitutes will be allowed. All plants shall be free of fungus and insect damage. All plants shall be healthy, well shaped, not soft or force grown and not root bound.

Plants are available from **Andreasens Green** wholesale nursery, contact Darren (02) 8777 4713, email darren@andreasensgreen.com.au or approved equivalent.

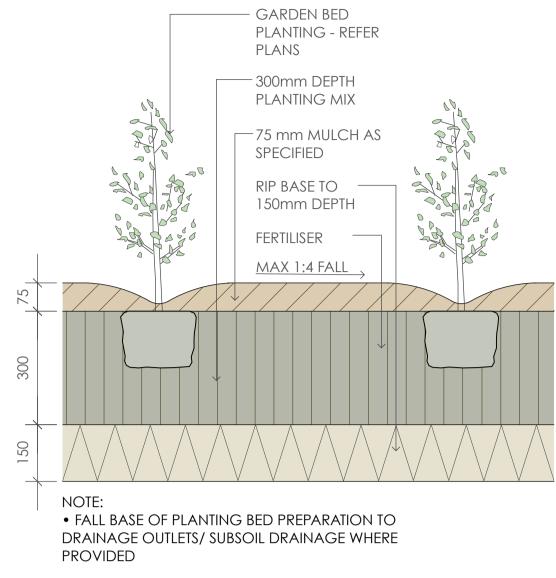

Planting Bed Detail scale 1:10

PREPARATION AND HARDWORKS

Excavating for Spot Planting To planting areas, excavate a hole for each plant large enough to provide not less than twice the depth and twice the diameter than the root ball of species to be planted.

Staking

Use durable hardwood, straight, free from knots or twists, pointed at one end. Drive stakes into the ground a minimum one third of their length, avoiding damage to the root system.

• 75 Litre trees in 2 x 38x38x1800mm Hardwood Stake with double Nylon tie TIES: Provide a 50mm wide Nylon webbing tie per stake, fixed securely to the stakes, one tie at half the height of the main stem and the other as necessary to stabilise the plant.

Porous Pavement

MATERIAL: Porous pavement shall be 115x230x80mm porous paving installed to manufacturers recommendations and specifications as available from Boral Pty Ltd (Ph 1300 134 002) or approved equivalent. Sample to be provided for approval by Superintendent.

Concrete Edge

MATERIALS: Concrete to be off white colour. INSTALLATION: Supply and install 150 x 100mm (width) reinforced flush concrete kerb to locations as approved on site by the Superintendent. Provide flexible joints at maximum 3 metre intervals in colour to match concrete. Lightly expose aggregate through rinsing / sponging. Tool finish exposed edges with 10mm pencil round to prevent chipping.

GREENLAND DESIGN												
TWELVE MONTHS MAINTENANCE SCHEDULE	Jan	Feb	Mar	Apr	May	Jun	Jul	Aug	Sep	Oct	Nov	Dec
Plant Care												
Monitoring												
Pruning as required												
Deadhead /tip pruning												
Slow release fertilise												
Rapid suluble fertilise as required												
Cut back perenials and grasses												
Watering as required												
Garden Bed												
Edging												
Remove weeds and herbicide spraying as required												
Top up mulch as required												
Dead foliage removal												
Pest Management												
Monitoring and herbicide spraying as required												
Turfed Area												
Fertilise												
Make good turf as required												
Winter clean up												
Remove dead foliage and pruning as required												




LOCKED BAG 5022 PARRAMATTA NSW 2124 PHONE No 1800 738 718 https://www.dpie.nsw.gov.au/land-and-housing-corporation

 $\Delta \bigcirc \bigcirc \bigcirc \bigcirc \bigcirc \bigcirc$ Barry Rush & Associates Pty Ltd Architects. Nominated Architect: Barry John Rush ARB Registration No 3753 Suite 25A. 2 Beattie Street, Balmain, NSW Phone: (02) 9555 8028 Email: info@barryrush.com.au

www.barryrush.com.au

			ARCHITECT	BUSINESS PARTNER:	PROJECT:	TITLE:		STATUS: DA		
			BARRY RUSH & ASSOCIATES PTY LTD PH (02) 9555 8028		HOUSING DEVELOPMENT	LANDSCAPE DETAI		DATE: SCALE	PROJ:	PROJECT No.
2	2/06/2023	FOR DA		_	10-16 ALBERT STREET	SPECIFICATION		22/06/2023 1:10	BGZDZ	
. 0	4/05/2023	FOR DA	BARRY RUSH & ASSOCIATES PTY LTD PH (02) 9555 8028		CASINO NSW	SPECIFICATION			$CL \stackrel{CHECKED:}{\longrightarrow} G$	D Bue
V [DATE	NOTATION/AMENDMENT		_		FILE:	PLOTTED:	TYP"SHEET:		REV:
	do not s	SCALE DRAWINGS. CHECK ALL DIMENSIONS ON SITE. FIGURED DIMENSIONS TAKE PRECEDENCE.			LOTS 22, 23, 24 & 25 IN DP36270	2733		LA 2	of 2	В

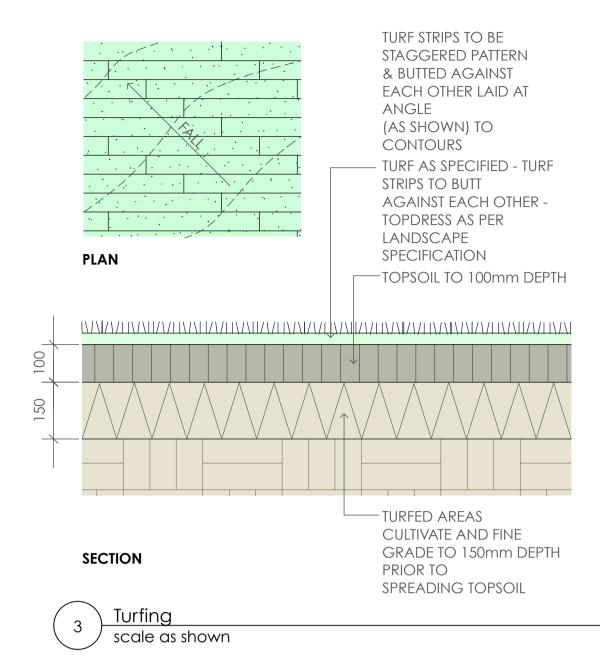

MAINTENANCE / PLANT ESTABLISHMENT

Maintenance shall apply to all hard and soft landscape materials installed prior to the "handover" and acceptance by Principles Representative and the Site Superintendent. The maintenance period shall convenience at the granting of practical completion and shall extend for 12 months.

Maintenance shall consist of the following works:

- Follow a daily watering programme to be approved by Superintendent. Water all plants individually, twice per week or when necessary to ensure constant plant growth.

- Apply appropriate weed control sprays and hand weed as required to maintain planting areas, native grassing bed areas, paved areas, and tree pits in turf free of weed or rogue grass growth.

- Regularly tidy and top up mulch and trim edges to prevent spill over onto paved / grassed areas.

 Spray to control pests and diseases. - Replace plants, which fail with plants of a similar size and quality as originally specified to approval of Superintendent. Costs of replacement shall be the responsibility of the Contractor. Replacement planting will be undertaken within 2 weeks of identification of dead material or instruction be the Superintendent. - Report any incidence of plants stolen or destroyed by vandalism.

- Adjust stakes and ties to plants as necessary. Ensure that strangulation of plants does not occur.

- Prune and shape plants as directed or where necessary.

- Make good any defects or faults arising out of defective workmanship or materials. - Make good any erosion or soil subsidence, which may occur including soft areas in pathways.

- A final inspection shall be made by the Superintendent before handover. Any items requiring rectification shall be repaired before the works are finally approved, and retention moneys released.

NOTE:


- All finished levels are to be verified by Contractor on site.

- All landscape works be in strict accordance with Council's landscape code and guidelines

- This plan to be used in conjunction with all other submitted architectural, hydraulics and engineering drawing where applicable.

Plant Sche	edule		
ID	Qty	Common Name	E
Trees			Т
BacMur	10	Grey Myrtle	E
CalSpp	5	Bottlebrush	1
CorWil	4	Red Flowering Gum	1
ElaRet	5	Blueberry Ash	E
TriLus	2	Water Gum	1
Shrubs			T
AcaGree	105	Green Mist	
AcmChe	70	Cherry Surprise Lilly Pilly	1
AcmeRed	11	Red Head Lilly Pilly	
AcmFor	49	Forest Flame	/
AlpCae	68	Native Ginger	
CalAnz	54	White Bottle Brush	(
CalEnd	58	Scarlet Bottlebrush	1
CalRed	67	Red Alert Bottle Brush	1
CorAlb	25	White Correa	1
CorStri	91	Narrow Palm Lily	1
CosEve	70	Evening Glow Mirror Plant	1
DorExc	29	Gymea Lily	
GreHon	39	Honey Gem Grevillea	(
GreLin	37	White Spider Flower	(
GreSer	11	Pink Spider Flower	(
LepCar	11	Tea Tree	l
MelCla	103	Claret Tops Honey Myrtle	1
MelThy	20	Thyme Honey-myrtle	1
SyzRes	38	Resilience Lilly Pilly	5
WesFru	48	Jervis Gem	١
Ground C	overs		
LomTan	287	Spiny-headed mat rush	l
DiaTas	129	Flax Lily	
MyoYar	106	Carpet Spreading Myoporum	1
DicEme	73	Emerald Falls Dichondra	
HypGol	99	Gold Nuget	ŀ
DiaCass	268	Cassa Blue Native Flax	
GooGold	20	Gold Cover Goodenia	0
CasCou	46	Cousin It	(
TheAus	41	Kangaroo Grass	1
VioHed	10	Native Violet	\
WesMun	68	Mundi	١
BanBir	92	Birthday Candle	E
BraMul	7	Break O Day	E
GrePoor	37	Royal Mantle Grevillea	1


18 December 2023

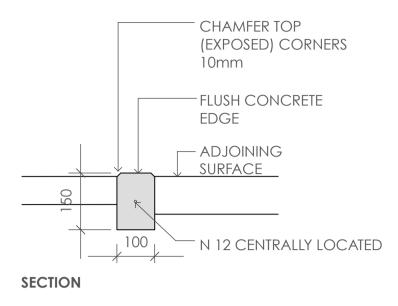

Concrete Edge scale 1:10

Botanical Name Size Mature Height | Mature Spread | Native (N) 5 - 10m 3.5 - 6m <u>Backhousia myrtifolia</u> 75Litre Ν 3 - 5m 2.0 - 3.5m Ν 75Litre <u>Callistemon spp.</u> 75Litre 3 - 6m 2.0 - 3.5m Ν Corymbia ficifolia 'Wildfire 75Litre 8 - 10m 3 - 4m Ν Elaeocarpus reticulatus Tristaniopsis laurina 'Luscious' 75Litre 6 - 8m 3.5 - 6m Ν 200mm 1.0 - 1.5m 0.8 - 1.0m Ν <u>Acacia cognata 'Green Mist'</u> 200mm 3.0 - 5.0m 1.2 - 1.5m Ν Acmena 'Cherry Surprise' Acmena smithii 'Red Head' 3.0 - 4.0m 200mm 5 - 6m Ν 1.5 - 2.0m 1.0 - 1.5m Acmena 'Forest Flame' 200mm Ν 200mm 0.9 - 1.5m 0.9 - 1.2m Ν Alpinia caerulea 200mm 0.9 - 1.1m 2.0 - 3.0m Callistemon citrinus 'White Anzac' Ν Callistemon citrinus 'Endevour' 200mm 3 - 5m 2.0 - 3.5m Ν 1.0 - 1.5m 2.0 - 3.0m Callistemon 'Red Alert' 200mm Ν 200mm 0.9 - 1.5m 0.9 - 1.2m Ν Correa alba 200mm 1 - 2m 0.8 - 1.0m Ν Cordyline stricta congesta 1.2 - 1.5m 0.9 - 1.2m Coprosma 'Evening Glow' 200mm Ν 200mm 1.5 - 2m 1.2 - 2.0m Ν Doryanthes excelsa 3.0 - 4.0m 2.0 - 3.0m Grevillea 'Honey Gem' 200mm Ν 200mm 0.9 - 1.5m 0.9 - 1.2m Ν Grevillea linearifolia 0.9 - 1.5m 0.9 - 1.2m Grevillea sericea 200mm Ν 2 - 3m 2.5 - 4m Ν Leptospermum "Cardwell" 200mm 0.9 - 1.1m 0.6- 1.0m Melaleuca 'Claret Tops' 200mm Ν 200mm 0.75 - 0.9m 0.6 - 0.9m Ν Melaleuca thymifolia 200mm 1.2 - 2.0m Syzygium 'Resilience' 2 - 3m Ν 0.8 - 1.2m 0.8 - 1.2m Ν Westringia fruticosa 'Jervis Gem' 200mm 0.45 - 0.6m 0.6 - 0.9m Lomandra longifolia 'Tanika' 150mm Ν 150mm 0.4 - 0.5m 0.4 - 0.5m Dianella tasmanica 'Tasred' Ν 0.05 - 0.1m 0.8 - 1.0m Myoporum parvifolium 'Yareena' 150mm Ν 0.0 - 0.3m 150mm 0.9 - 1.2m Ν Dichondra 'Emerald Falls' 0.10 - 0.15m 0.8 - 1.0m Hymenosporum flavum 'Gold Nuget' 150mm Ν 140mm 0.3 - 0.4m 0.3 - 0.4m Dianella caerulea 'Cassa Blue' Ν 0.05 - 0.1m 0.8 - 1.0m Goodenia ovata 'Gold Cover' 150mm Ν 150mm 0.10 - 0.15m 0.8 - 1.0m Casuarina 'Cousin It' Ν 150mm 0.9 - 1.5m 0.3 - 0.6m Ν Themeda australis 150mm 0.0 - 0.3m 1.2 - 2.0m Viola hederacea Ν 0.45 - 0.6m 0.9 - 1.2m Ν Westringia fruticosa 'Mundi' 150mm 0.45 - 0.6m 0.9 - 1.2m Banksia spinulosa 'Birthday Candle' 150mm Ν 150mm 0.2 - 0.3m 0.4 - 0.5m Ν Brachyscome multifida 150mm 0-0.1m 2.0 - 3.0m Ν

Grevillea 'Poorinda Royal Mantle'

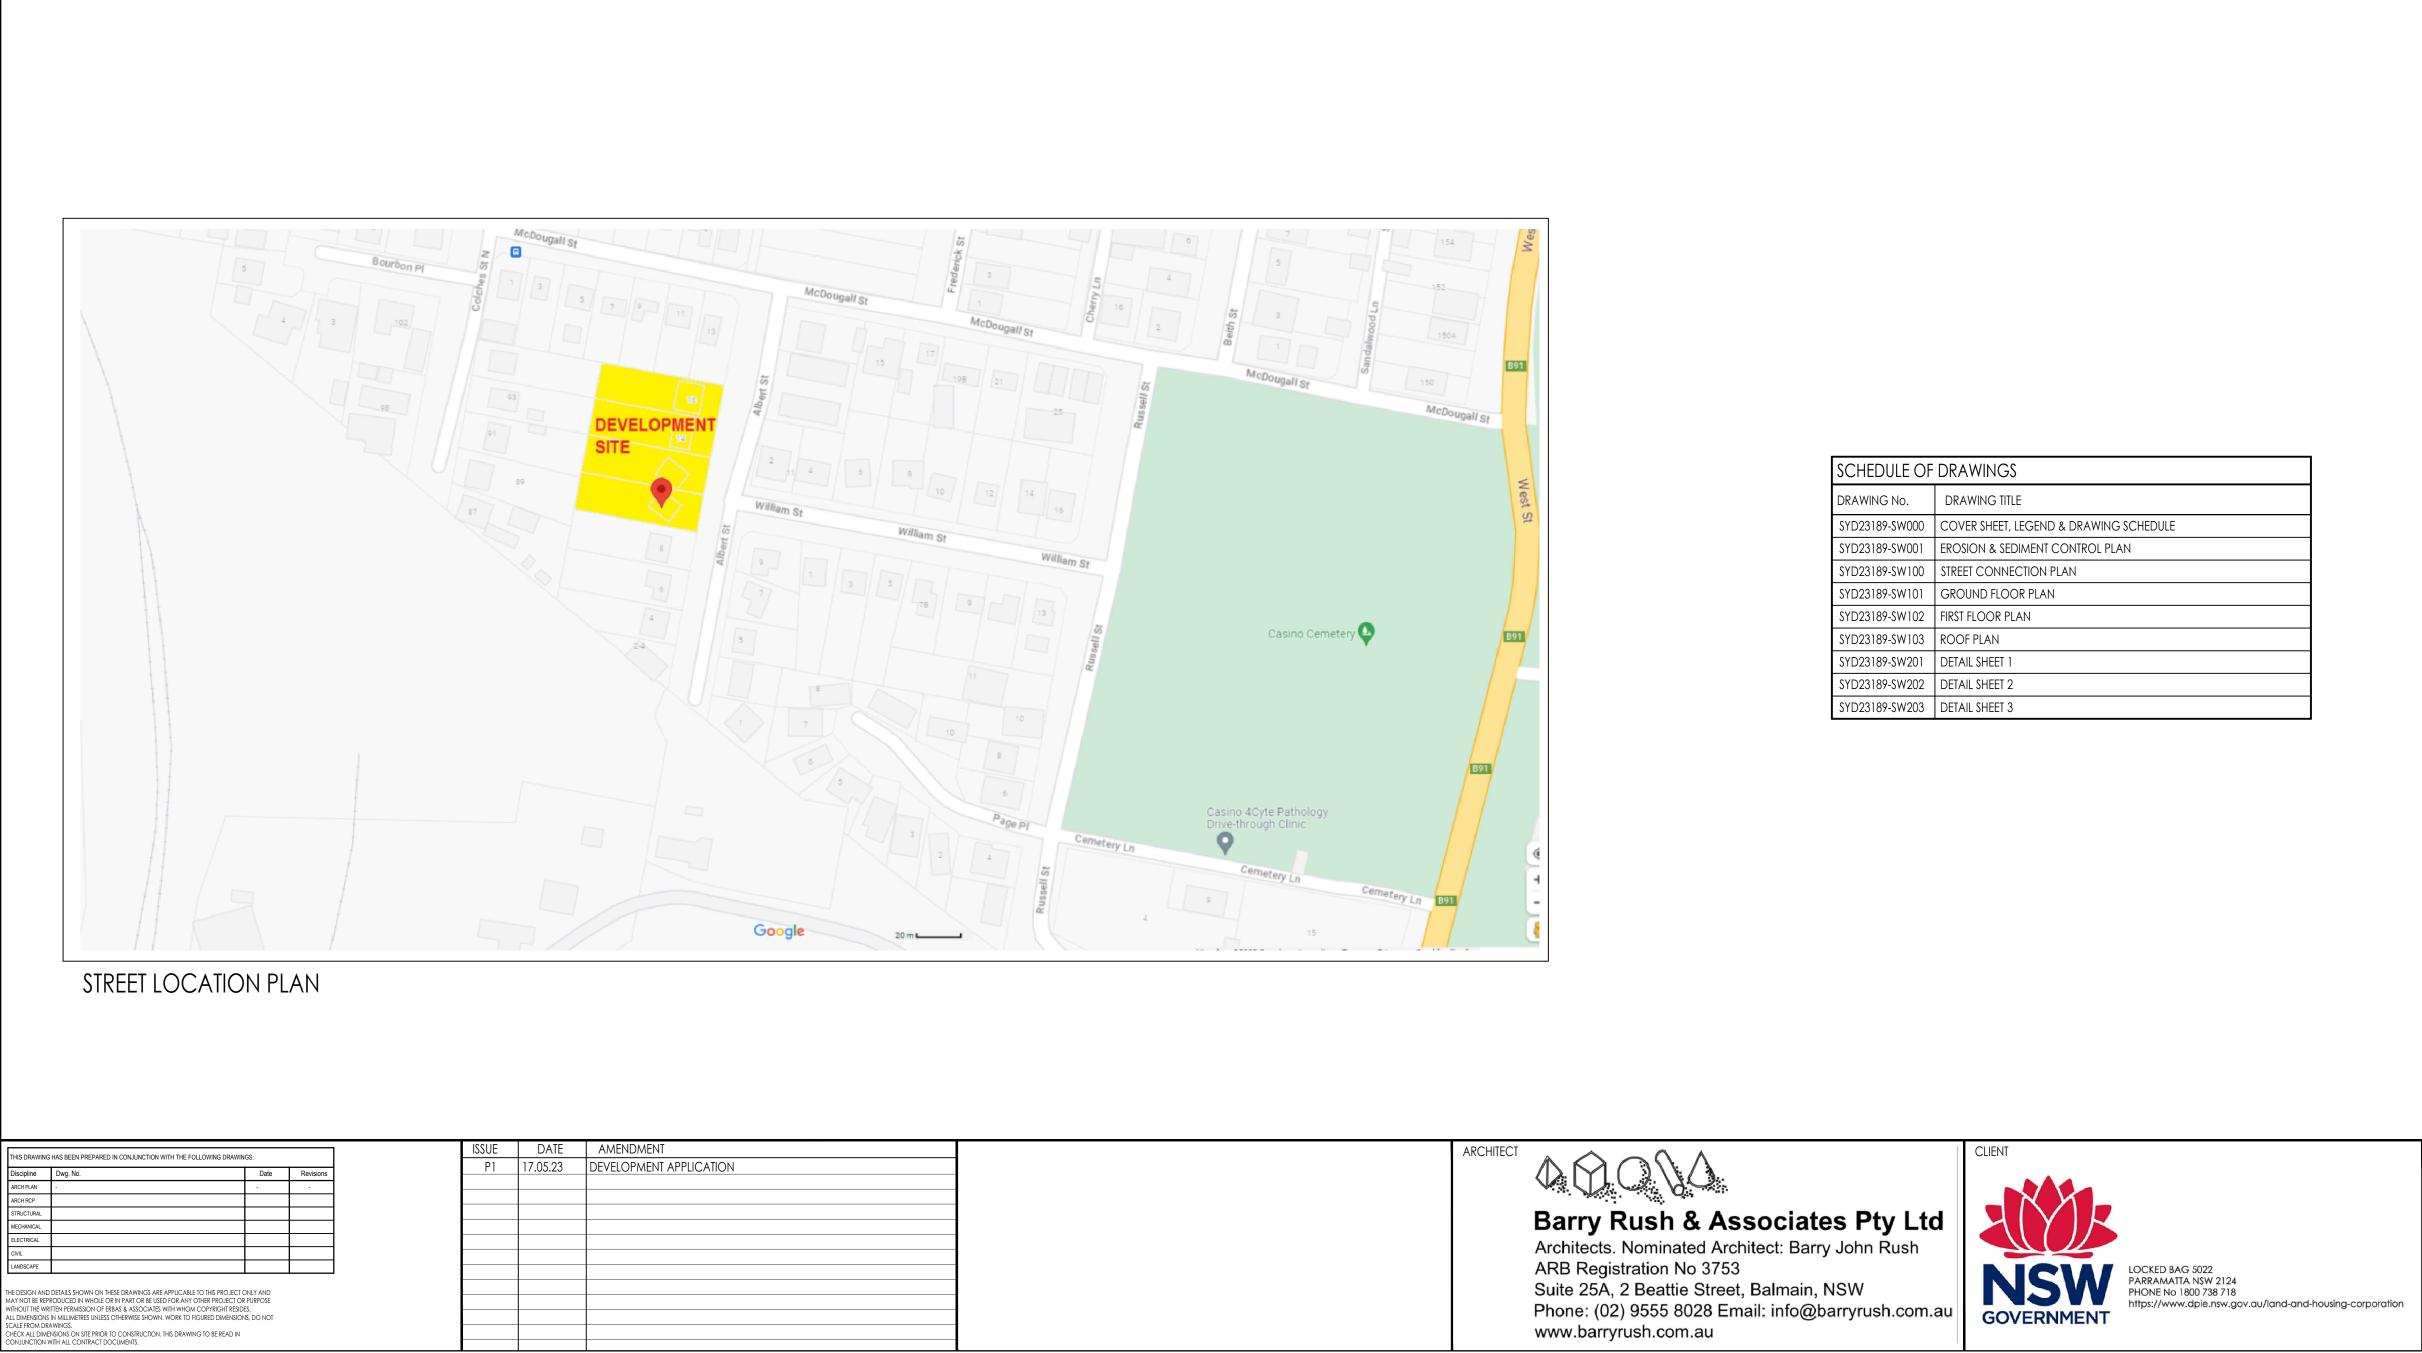

10-16 ALBERT STREET, CASINO STORMWATER SERVICES

LEGEND

ABBREVIATIONS

AEP ARI CO Ø DP DWG e GMS GTD IL kPa L L/s m 2 m3 m/s mM NOM OF PVC Q100	ANNUAL EXCEEDANCE PROBABILITY AVERAGE RECURRENCE INTERVAL CLEAROUT DIAMETER DOWNPIPE DRAWING EXISTING GALVANISED MILD STEEL GRATED TRENCH DRAIN INVERT LEVEL KILOPASCALS LITRES LITRES PER SECOND METRES SQUARE METRES CUBIC METRES CUBIC METRES METRES PER SECOND MILLIMETRES NOMINAL OVERFLOW UNPLASTICIZED POLYVINYL CHLORIDE QUANTITY OF FLOW FOR 100 YEAR ARI STORM
m3 m/s MOM OF PVC Q100 Q20 RDP RHS	CUBIC METRES METRES PER SECOND MILLIMETRES NOMINAL OVERFLOW UNPLASTICIZED POLYVINYL CHLORIDE QUANTITY OF FLOW FOR 100 YEAR ARI STORM QUANTITY OF FLOW FOR 20 YEAR ARI STORM RAINWATER DOWNPIPE RECTANGULAR HOLLOW SECTION
rl SAC SWP UNO	REDUCED LEVEL SEWER ACCESS CHAMBER STORMWATER PIT UNLESS NOTED OTHERWISE

PIPE SERVICES

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EXISTING/NATURAL CONTOUR STORMWATER DRAINAGE EXISTING LARGE STORMWATER RAINWATER DRAINAGE SUBSOIL DRAINAGE CATCHMENT EXTENT SEDIMENT FENCE EXISTING AUTHORITY WATER MAIN EXISTING AUTHORITY SEWER MAIN EXISTING AUTHORITY TELECOMMUNICATION CONDUIT

SYMBOLS

•	PE
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SCHEDULE OF	DRAWINGS
DRAWING No.	DRAWING TITLE
SYD23189-SW000	COVER SHEET, LEGEND & DRAWING SCHEDULE
SYD23189-SW001	EROSION & SEDIMENT CONTROL PLAN
SYD23189-SW100	STREET CONNECTION PLAN
SYD23189-SW101	GROUND FLOOR PLAN
SYD23189-SW102	FIRST FLOOR PLAN
SYD23189-SW103	ROOF PLAN
SYD23189-SW201	DETAIL SHEET 1
SYD23189-SW202	DETAIL SHEET 2
SYD23189-SW203	DETAIL SHEET 3

BUILDING SERVICES ENGINEER Sydney Melbourne Manila L1, 15 Atchison Street, St Leonards NSW 2065 Ph: (02) 9437 1022 general@erbas.com.au www.erbas.com.au	DESIGNED IY CHECKED MS NORTH POINT	PROJECT MULTI-DWELLING HOUSING DEVELOPMENT 10-16 ALBERT STREET, CASINO NSW (RICHMOND VALLEY COUNCIL) CLIENT PROJECT REFERENCE: BGZDZ	DRAWING TITLE STORMWATER SERVICES COVER SHEET, LEGEND & DRAWING SCHEDULE SCALE at B1 PROJECT NO. DRAWING - DATE MAY 2023 DRAWN IY SYD23189-SW00


INSPECTION	STORMWATER INSPECTION REQUIREMENTS		ERBAS REPRESENTATIVE		PASS	F	AIL
NO.		NAME	SIGNATURE	DATE	TICK 🗸	OR	N/A
1	INSPECTION OF INGROUND STORMWATER DRAINAGE PRIOR TO BACKFILL (MANDATORY)						
2	INSPECTION OF ANY INGROUND STORMWATER DRAINAGE NOT VIEWED AT INSPECTION NO. 1 (OPTIONAL)						
3	INSPECTION OF INFILTRATION PIT / TANK / TRENCH PRIOR TO BACKFILL (JOB SPECIFIC)						
4	FINAL INSPECTION ON COMPLETION OF ALL LANDSCAPING & POST COMMISSIONING OF THE STORMWATER SYSTEM (MANDATORY)						
5	SURVEY OF RAINWATER & ONSITE DETENTION TANKS & WORKS AS EXECUTED STORMWATER DRAWINGS (MANDATORY) *TO BE PROVIDED TO ERBAS PRIOR TO INSPECTION						


	IMPORTANT - FOR PRINC	IPAL CO	NTRACTC)R		
LEGISI ALL ST	ABLE THE ISSUE OF STORMWATER CERTIFICATION PERM ATION, SITE INSPECTIONS MUST OCCUR. THE PRINCIPA ORMWATER INSPECTIONS. ABSENCE OF INSPECTION V ISPECTIONS ARE TO BE COMPLETED BY ERBAS AS FOLL	L CONTRAC	TOR IS RESPO	ONSIBLE FOR	COORDIN	ATING
INSPECTION	STORMWATER INSPECTION REQUIREMENTS		BAS ENTATIVE	INSPECTION	PASS	FAIL
NO.		NAME	SIGNATURE	DATE	tick 🗸	OR N/A
1	INSPECTION OF INGROUND STORMWATER DRAINAGE PRIOR TO BACKFILL (MANDATORY)					
2	INSPECTION OF ANY INGROUND STORMWATER DRAINAGE NOT VIEWED AT INSPECTION NO. 1 (OPTIONAL)					
3	INSPECTION OF INFILTRATION PIT / TANK / TRENCH PRIOR TO BACKFILL (JOB SPECIFIC)					
4	FINAL INSPECTION ON COMPLETION OF ALL LANDSCAPING & POST COMMISSIONING OF THE STORMWATER SYSTEM (MANDATORY)					
5	SURVEY OF RAINWATER & ONSITE DETENTION TANKS & WORKS AS EXECUTED STORMWATER DRAWINGS					

DETERMINED by the NSW Land and Housing Corporation	on:
18 December 2023	Ì





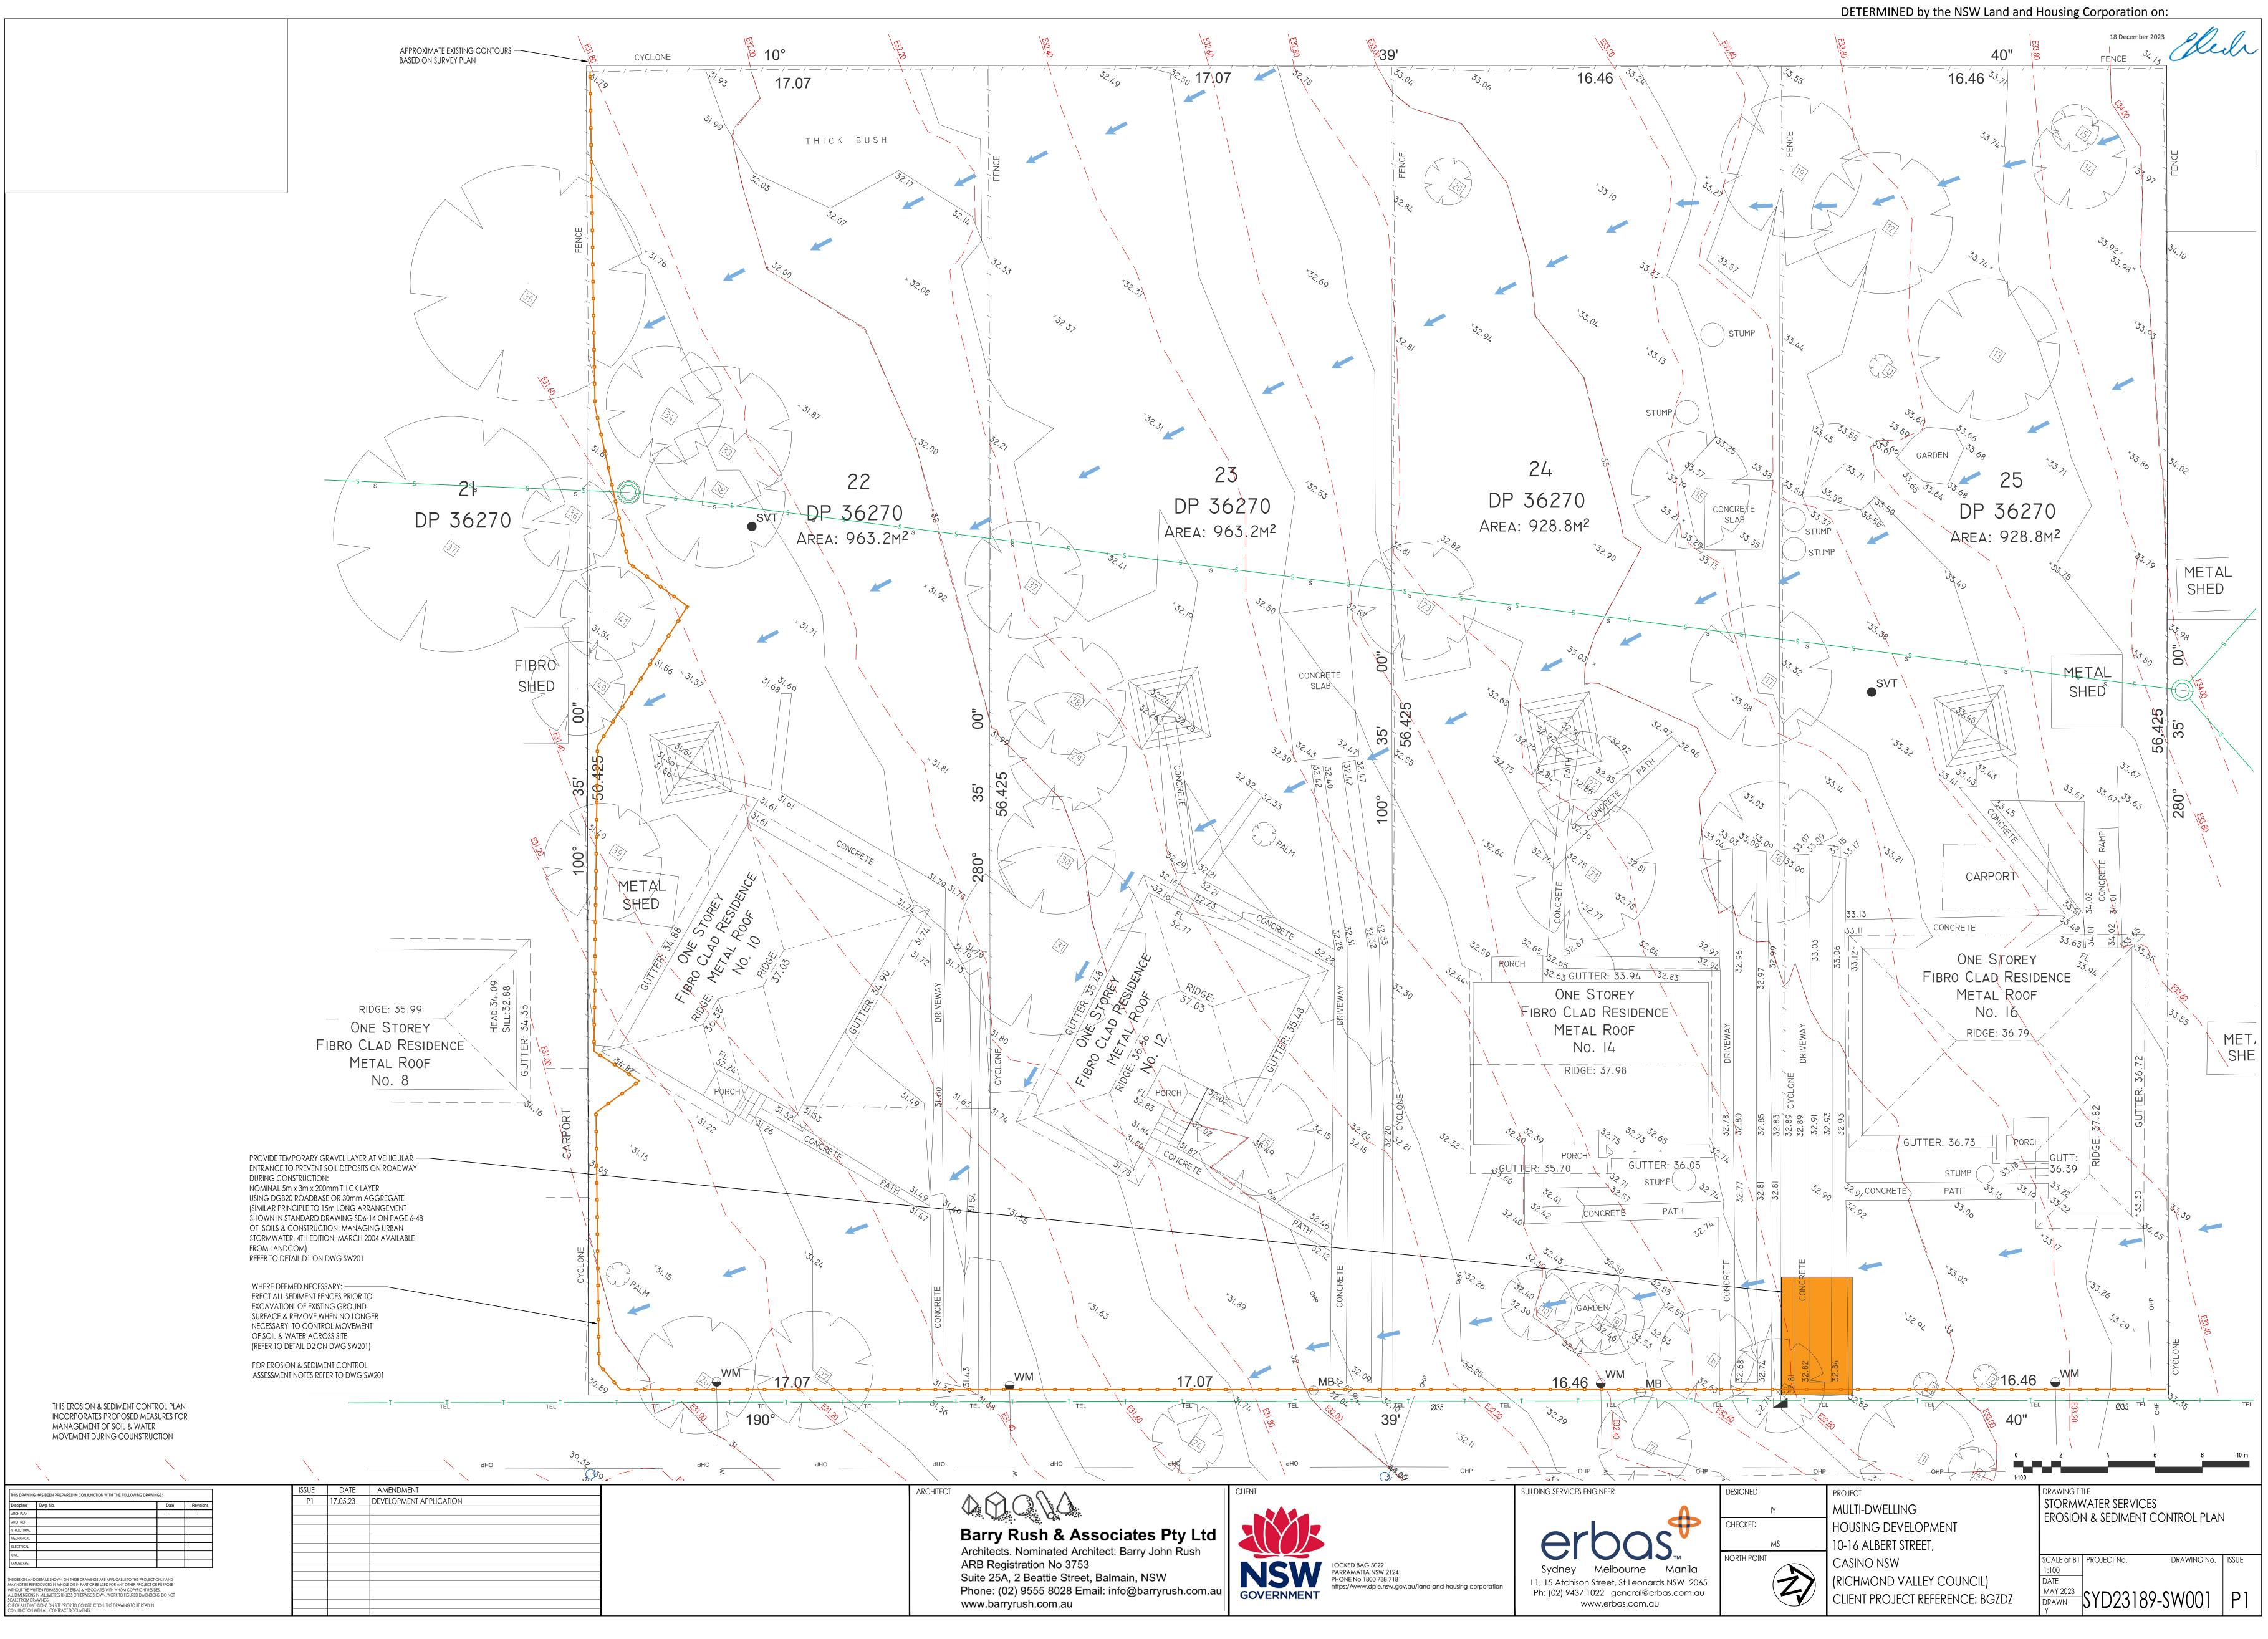

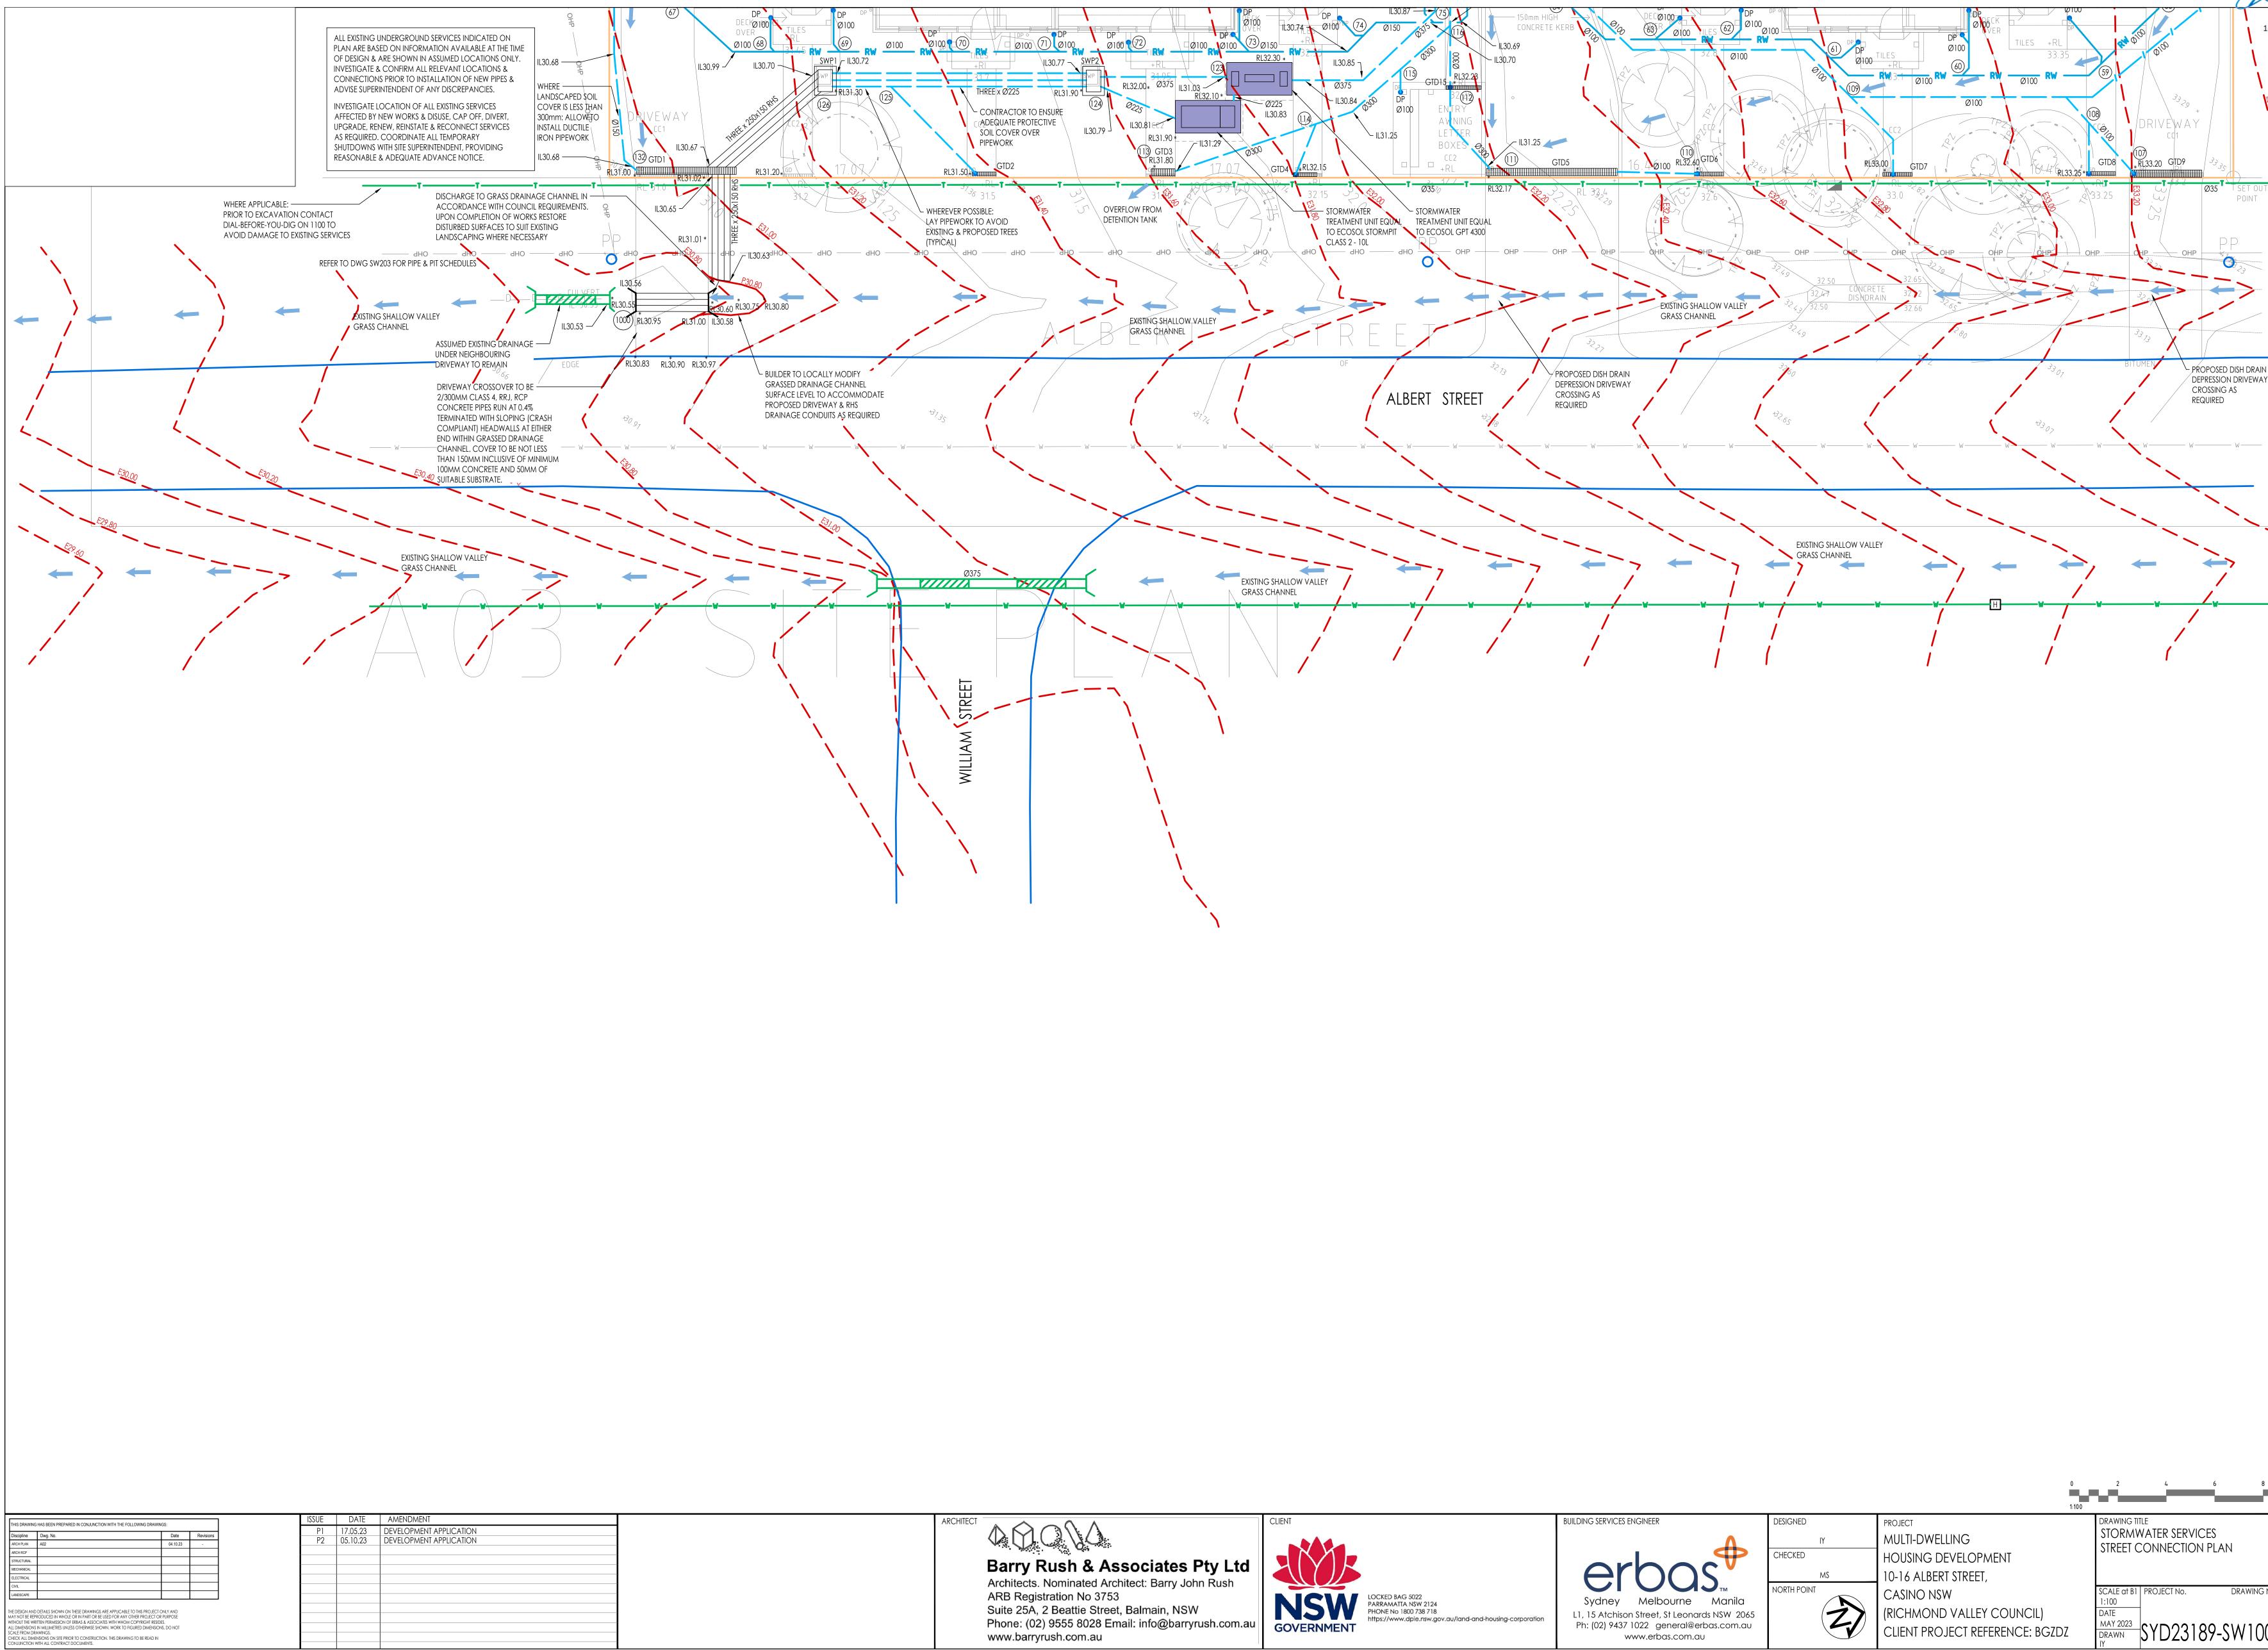


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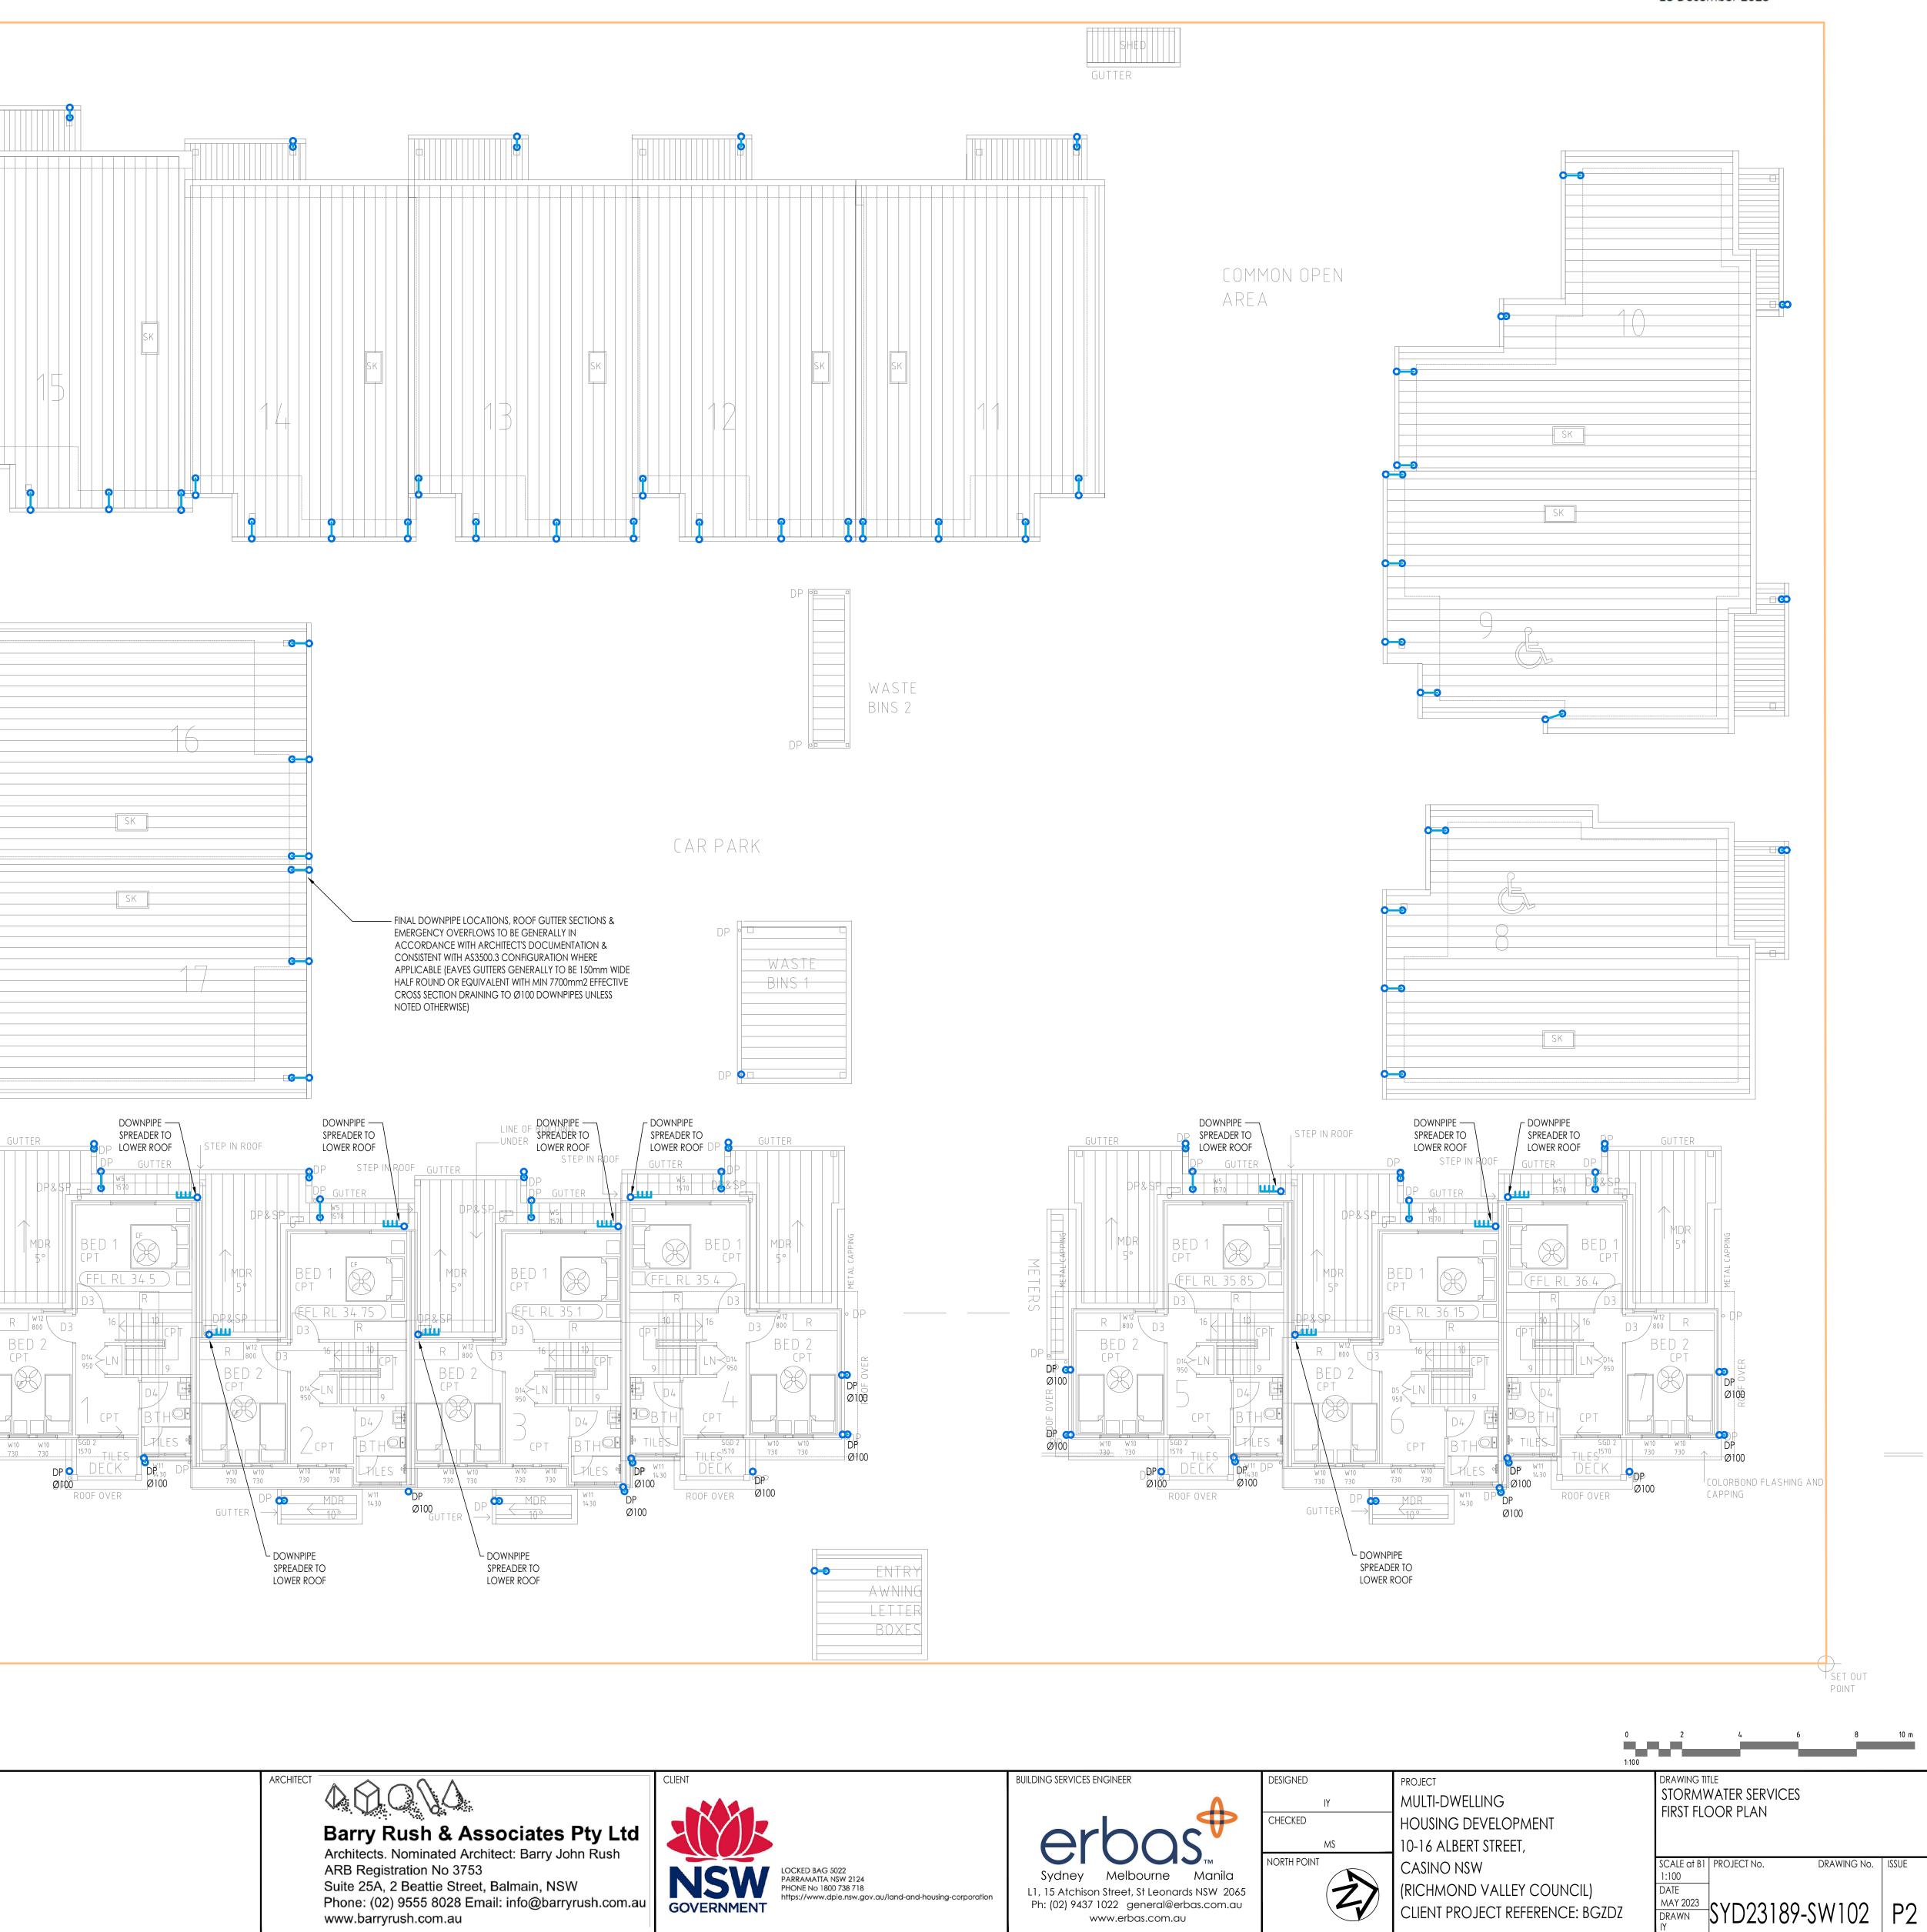
BUILDING SERVICES ENGINEER
erbas [♣]
Sydney Melbourne Manila
L1, 15 Atchison Street, St Leonards NSW 2065 Ph: (02) 9437 1022 general@erbas.com.au www.erbas.com.au

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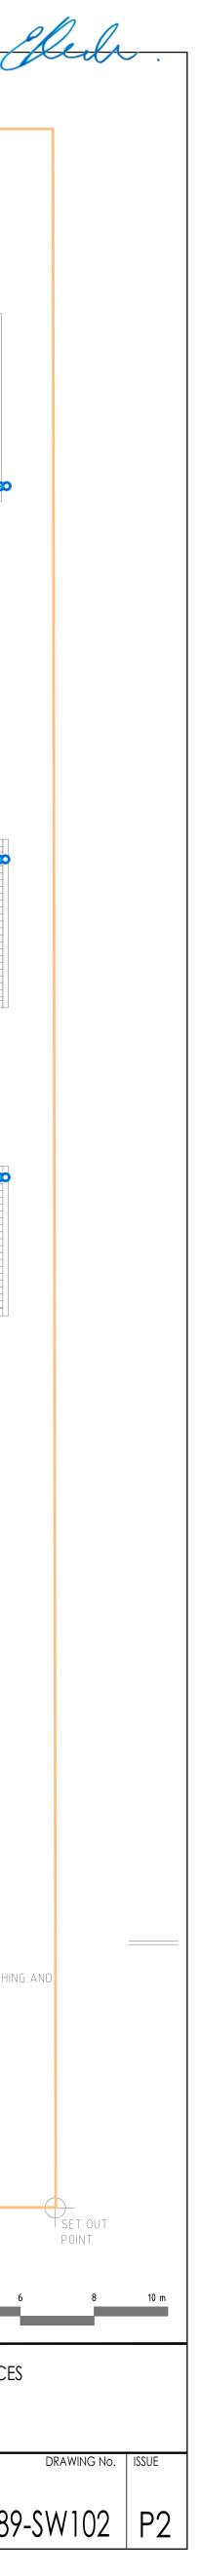


		METAL CAPPING
THIS DRAWING HAS BEEN PREPARED IN CONJUNCTION WITH THE FOLLOWING DRAWINGS: Discipline Dwg. No. ARCH PLAN A04 ARCH PLAN A04 ARCH RCP	ISSUE DATE AMENDMENT P1 17.05.23 DEVELOPMENT APPLICATION P2 06.10.23 DEVELOPMENT APPLICATION Image: I	



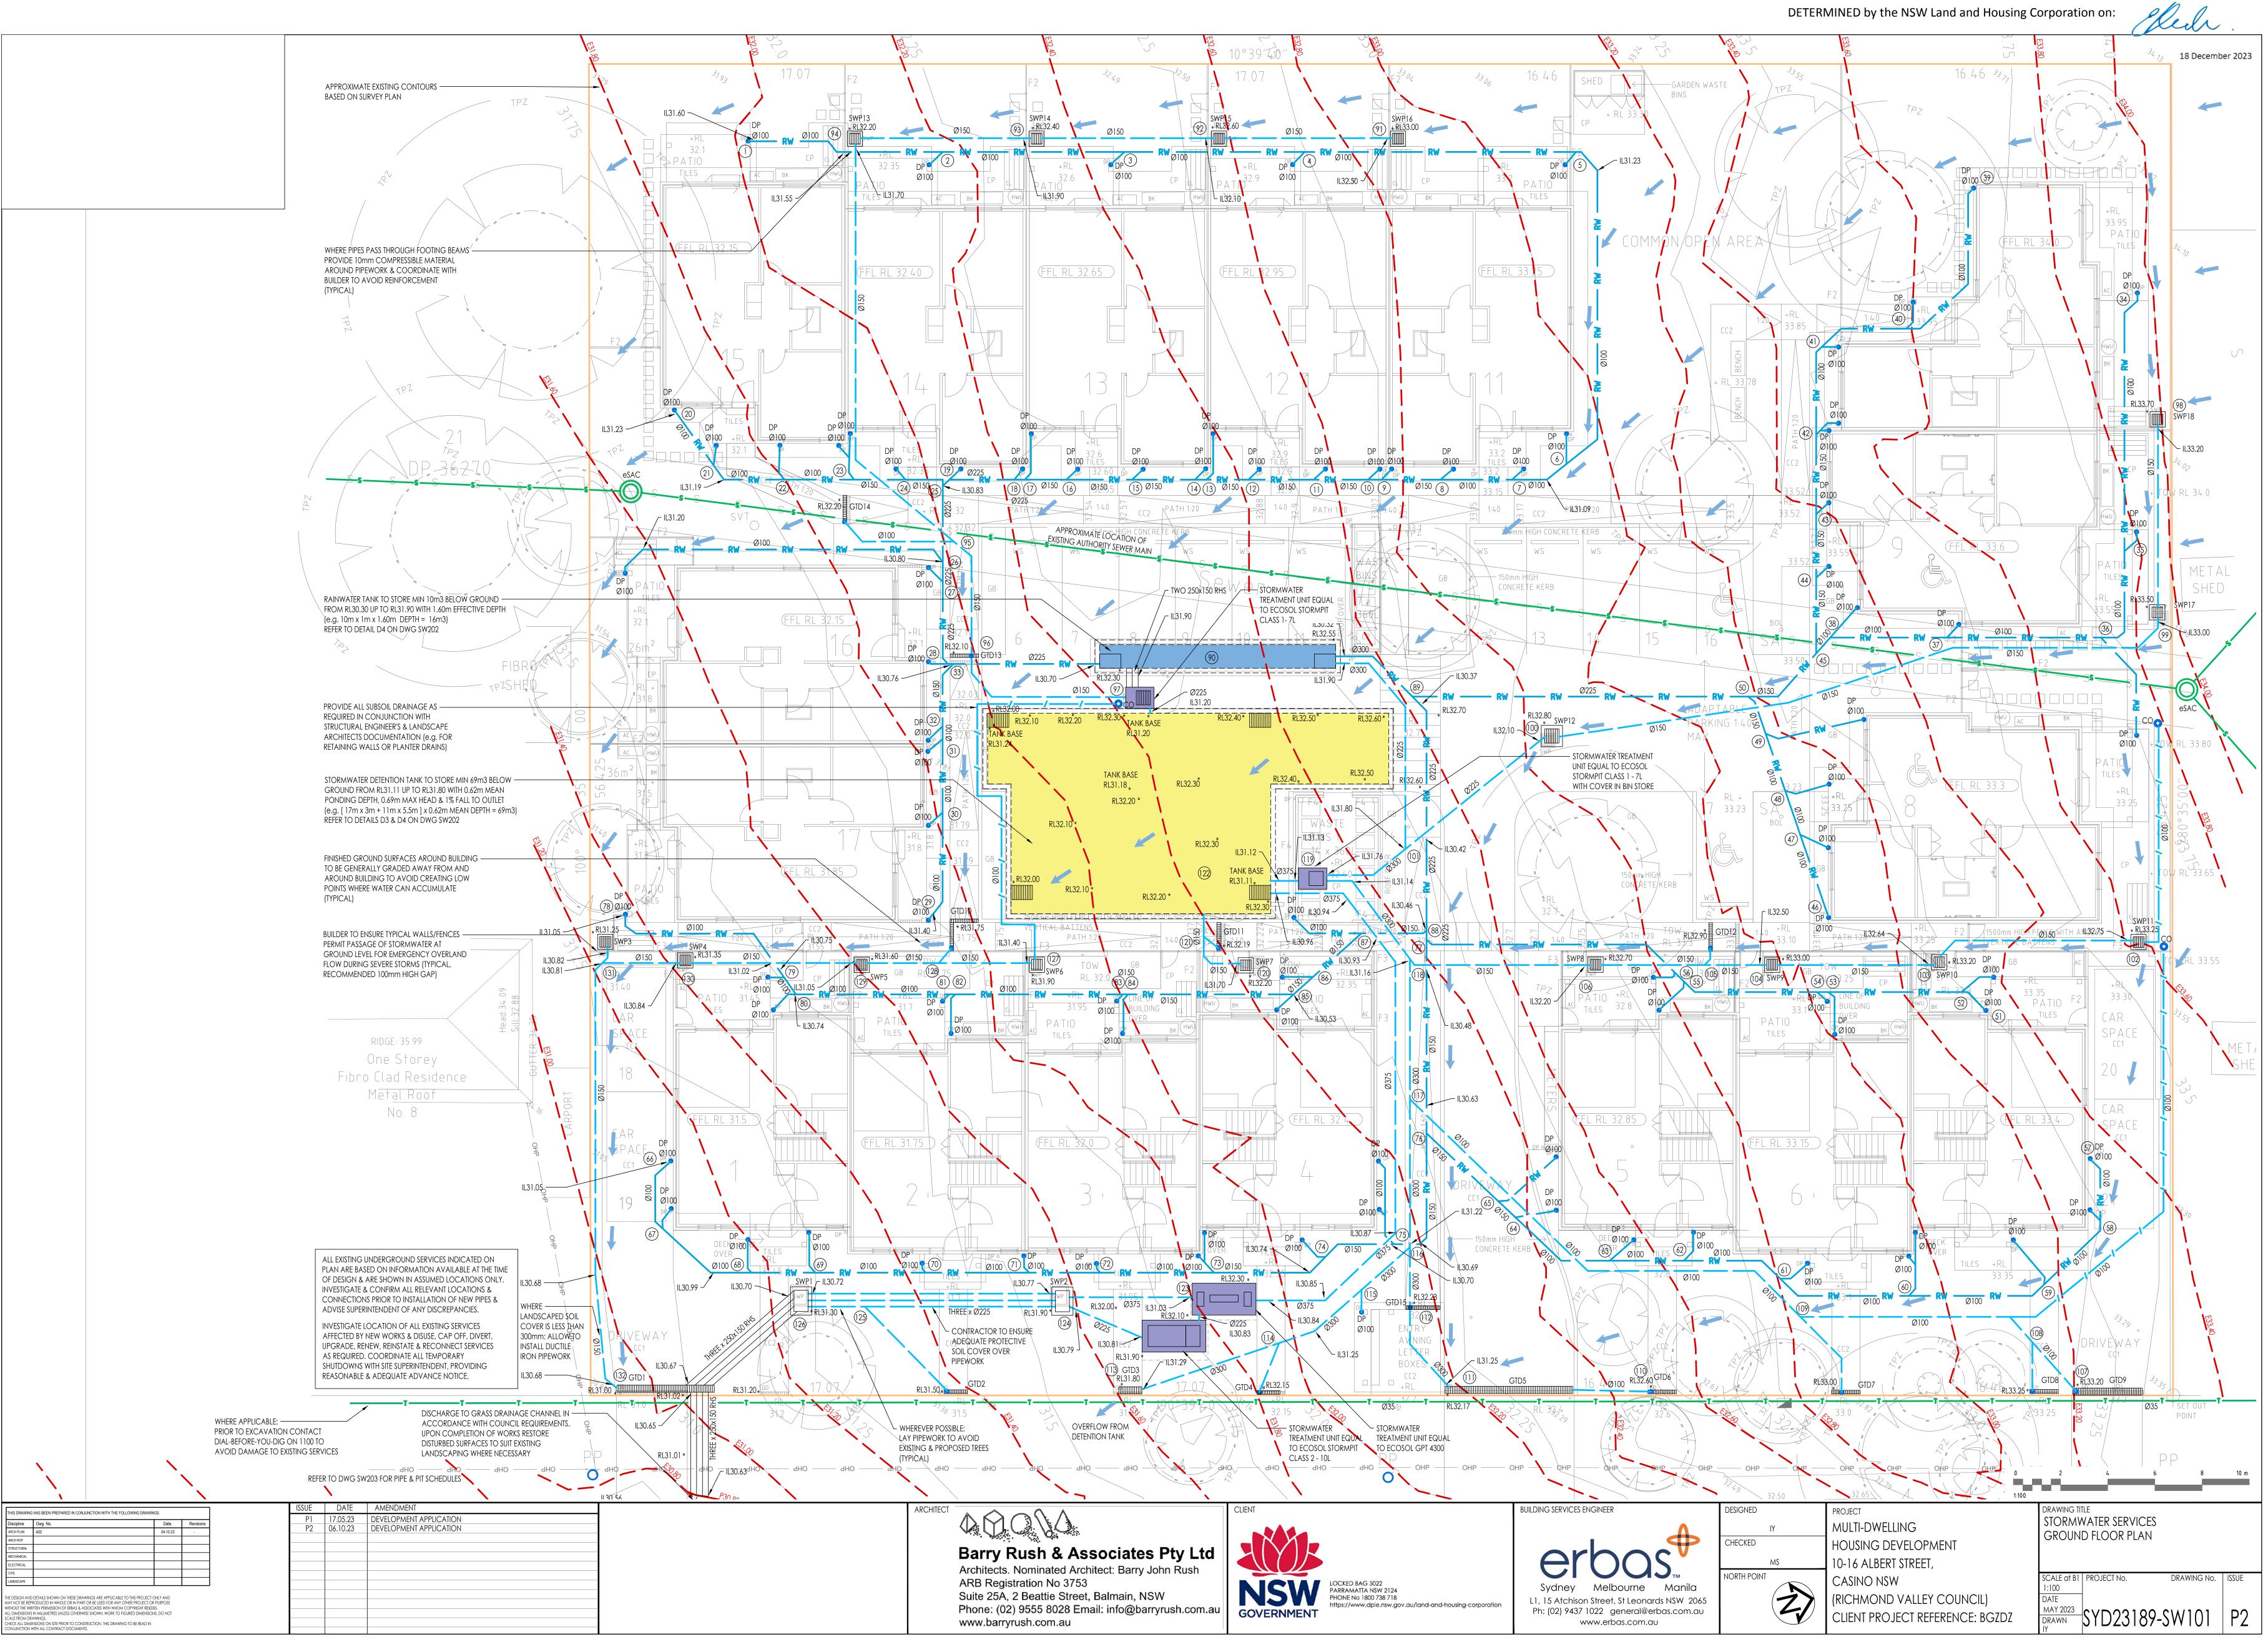

DETERMINED by the NSW Land and Housing Corporation on:



			25x1.04=26m2 Q20=1.5L/s GUTTER
			4x1.02=4m2 Q20=9.2L
			RIDGE RL 36.15 FL
			4x1.02=4m2 Q20=0.2L/s
			Q20=0.2L/s
			DP
			DP GUTTER
Discipline Dwg. No. Date Revisions ARCH PLAN A05 04.10.23 - ARCH RCP STRUCTURAL ELECTRICAL CN/L LANDSCAPE	ISSUE DATE P1 17.05.23 P2 06.10.23	AMENDMENT DEVELOPMENT APPLICATION DEVELOPMENT APPLICATION	
THE DESIGN AND DETAILS SHOWN ON THESE DRAWINGS ARE APPLICABLE TO THIS PROJECT ONLY AND MAY NOT BE REPRODUCED IN WHOLE OR IN PART OR BE USED FOR ANY OTHER PROJECT OR PURPOSE WITHOUT THE WRITTEN PERMISSION OF ERBAS & ASSOCIATES WITH WHOM COPYRIGHT RESIDES. ALL DIMENSIONS IN MILLIMETRES UNLESS OTHERWISE SHOWN. WORK TO FIGURED DIMENSIONS, DO NOT SCALE FROM DRAWINGS. CHECK ALL DIMENSIONS ON SITE PRIOR TO CONSTRUCTION. THIS DRAWING TO BE READ IN CONJUNCTION WITH ALL CONTRACT DOCUMENTS.			











Based on Soils and Construction: Managing Urba	in Stormwater	- 4th Editior	n - March	2004
Assumed area of Soil Disturbance	=	3784	m2 =	0.3784 ha
Rainfall Erosivity Factor R	=	3400	for	CASINO from APPENDIX B: MAP 2 ON PAGE B-4
Take Site Slope	=	4	%	
Indicative Ero	osion Hazard is	LOW		based on Section 4.4.1 Figure 4.6 on page 4-10
Use Revised Universal Soil Loss Equation (RUSLE) to check:			
Soil Erodibility Factor K	=	0.060	for	CASINO from www.environment.nsw.gov.au/espade2web
Slope Length/Gradient Factor Ls	=	0.91	from API	PENDIX A: USING 80m LENGTH IN TABLE A1 ON PAGE A-9
Erosion Control Practice Factor P	=	1.3	from API	PENDIX A: TABLE A2 ON PAGE A-11
Ground Cover & Management Factor C	=	1.0	from API	PENDIX A: FIGURE A5 ON PAGE A-12
Soil Loss	=	241	t/ha/yr	
Soil Loss Class	=	3	for	SOIL LOSS BETWEEN 226 & 350t/ha/yr based on SEC
Erosion Haza	rd is therefore	LOW-MOD	ERATE	AND THERE ARE NO SEASONAL RESTRICTIONS ON SITE AC
For 1.0 t/m3 density, Average Annual Soil Loss	=	241	m3/yr	SINCE THIS IS GREATER THAN THAN 150m3/yr, A SEDIMEN
				UNLESS INDIVIDUAL SOIL DISTURBANCE AREAS CAN BE L
				FOR THE AREA TO BE DISTURBED ON THIS SITE, SEDIMEN
10yr 5min RAINFALL INTENSITY	=	186	mm/h	Refer to SECTION 2.1 ON PAGE 2-1, SECTION 4.4.1(a) ON
10yr 1hr RAINFALL INTENSITY	=	55.8	mm/h	LENGTHS OF SEDIMENT FENCING SHOULD BE ARRANGED
				Refer to SECTION 6.3.7 (e) ON PAGE 6-34 & SECTION 2.3.3

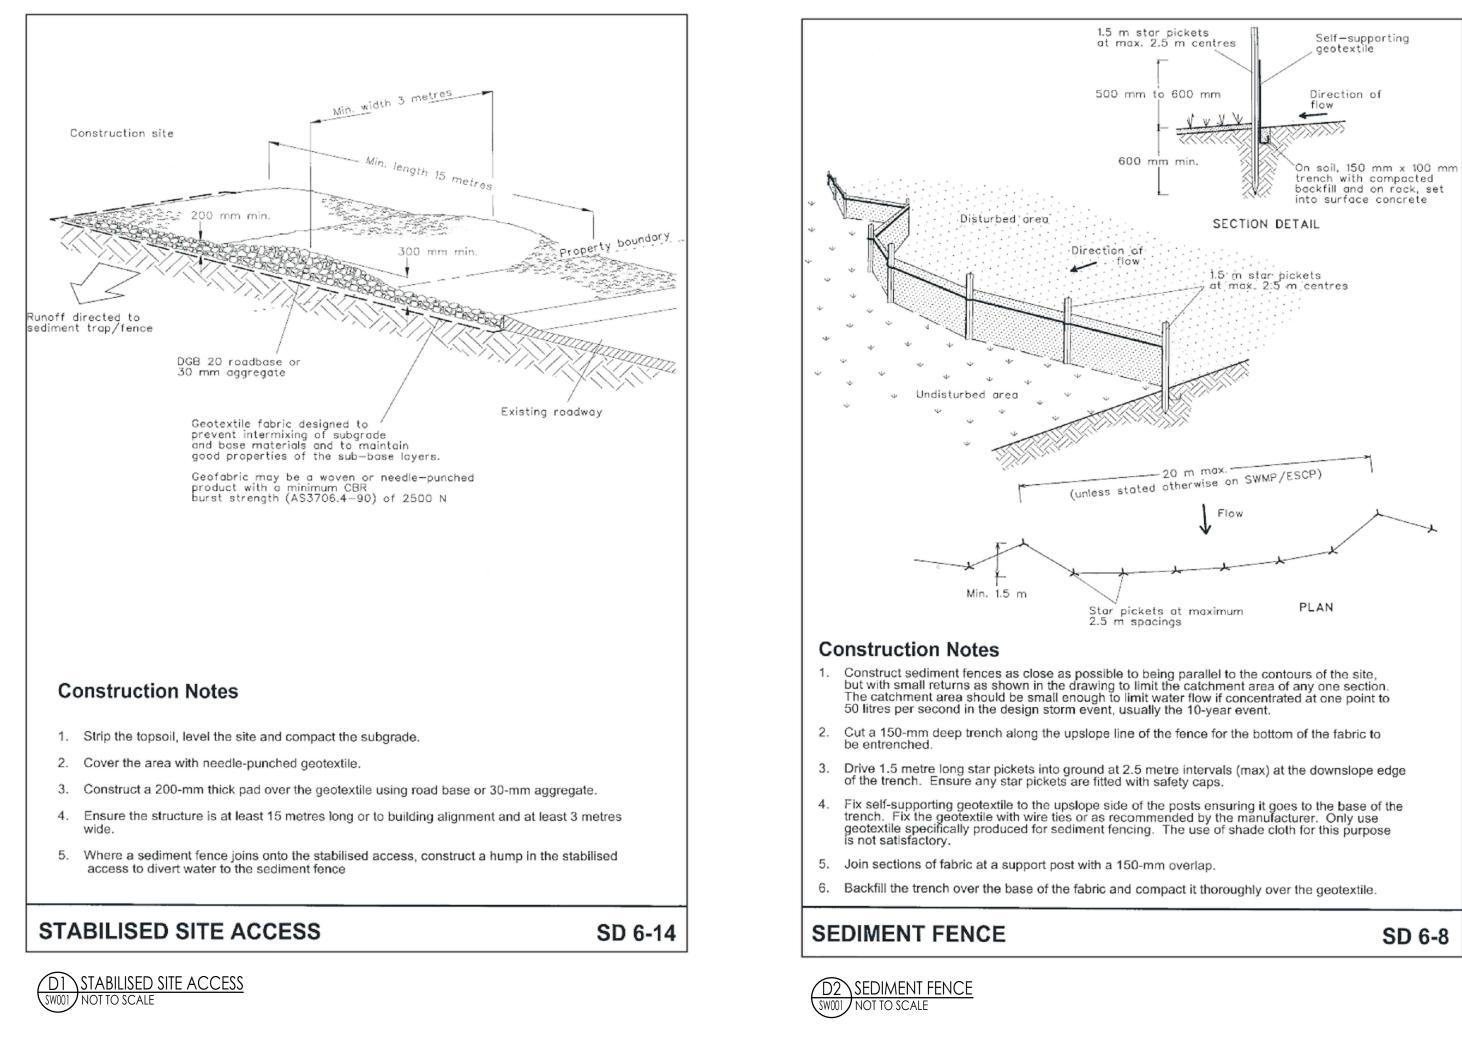

	IG HAS BEEN PREPARED IN CONJUNCTION WITH THE FOLLOWING DRAWI	NCS:		ISSUE	DATE	AMENDMENT
Discipline	Dwg. No.	Date	Revisions	P1	17.05.23	DEVELOPMENT APPLICATION
ARCH PLAN	Dwg. No.	Date	Revisions	-		
ARCH RCP		·	-	-		
STRUCTURAL						
MECHANICAL						
ELECTRICAL						
CIVIL						
LANDSCAPE						
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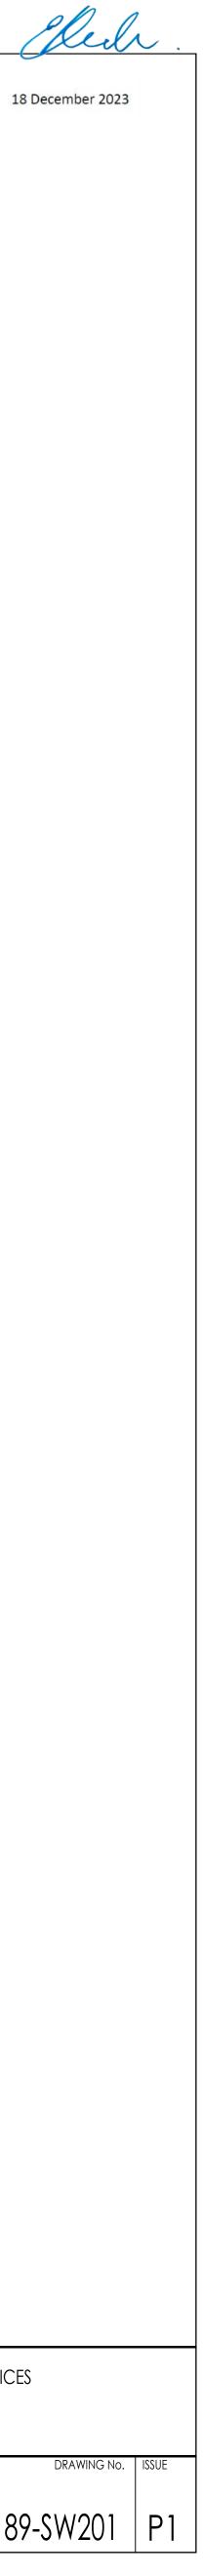


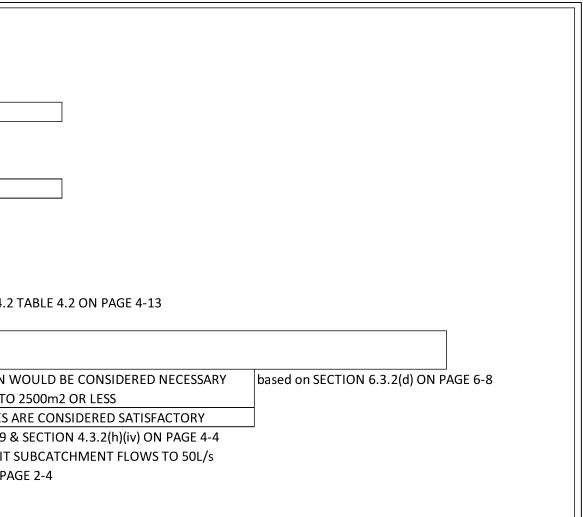DRAINS SOFTWATER MODELLING RESULT SUMMARY

STORMWATER DETENTION CALCULATION SUMMARY Project: 10-16 ALBERT STREET, CASINO

		5	YEAR ARI				2	O YEAR ARI				1	.00 YEAR ARI		
Storm	Existing	Detained	Overflow	Total	Max Water	Existing	Detained	Overflow	Total	Max Water	Existing	Detained	Overflow	Total	Max Wate
Duration	Runoff	Flow		Outflow	RL	Runoff	Flow		Outflow	RL	Runoff	Flow		Outflow	RI
	L/s	L/s	L/s	L/s	m	L/s	L/s	L/s	L/s	m	L/s	L/s	L/s	L/s	n
5min	99	82		82	31.34	168	100		100	31.45	250	118		118	31.59
10min	113	91		91	31.39	166	115		115	31.56	243	13 9		139	31.76
15min	108	90		90	31.39	182	116		116	31.57	217	139		139	31.76
20min	116	91		91	31.39	161	115		115	31.56	220	139		139	31.77
25min	<mark>99</mark>	86		86	31.36	154	112		112	31.54	208	137		137	31.75
30min	106	84		84	31.35	143	107		107	31.50	181	131		131	31.69
45min	104	84		84	31.35	121	94		94	31.41	161	122		122	31.62
1.0hr	79	71		71	31.28	129	100		100	31.45	139	113		113	31.55
1.5hr	70	65		65	31.25	103	81		81	31.33	126	95		95	31.42
2.0hr	68	64		64	31.24	104	77		77	31.31	133	100		100	31.45






	IANAGEMENT PLAN INFORMATION
DEVELOPMENT AUTHORITY:	Richmond Valley Council
SITE ADDRESS:	10-16 Albert Street, Casino NSW
	pment Control Plan 2021 - Part A-8 Multi Dwelling Housing pment Control Plan 2021 - Part I-9 Water Sensitive Design
- Survey plan prepared by RPS Aus	(18% of site) m2 (72% of site) ential lots ert Street and William Street, on west side of Albert Street. etralia East Pty Ltd - Drawing Reference 151687 [Rev 1] - dated 06/09/2022 indicates Australian Height Datum (AHD) site surface gh point of about RL34.13 at the northwest corner of the site down to about RL30.89 at the southeast corner of the site. The average
LOCAL FLOODING EFFECTS Based on the Casino Floodplain Ha	zard Categories map the subject property at is NOT considered to be affected by flooding.
for connection along the frontage of south. It is observed that some exist	property undertaken on 6 SEP 2022, it was observed that no existing formal underground street drainage or kerb inlet pit is available Albert Street. Surface runoff currently appears to drain along shallow valley grass channels on each side of the street, towards the ting residential driveway widths accommodate a short length pipe length to convey stormwater below the driveway surface, while erground pipe concealed below, but are simply depressed to allow flow across the lowest part of the driveway.
	n the new development will be directed to the existing ground surface beside Albert Street. This conceptual arrangement is also the y Richmond Valley Council engineering email advice (obtained on 20 APR 2023 from Travis Eggins).
in the early stages of the design pro recommended as a suitable option. Rainwater storage requirements for	- Development Control Plan 2021 - Part A-8 Multi Dwelling Housing, Section A-8.1.2 recommends Council advice should be obtained ccess. Council engineering advice was obtained on 20 APR 2023 and underground pipe discharge from the site was not Therefore, multiple shallow outlets from rainwater and detention tank storage are proposed. new residential dwellings are also typically provided to satisfy State Environmental Policy Building Sustainability Index (BASIX) tosed that at least 10000L rainwater storage will be provided for the development.
achieved. Based on the Model for U	- Development Control Plan 2021 - Part I-9 Water Sensitive Design, Table I-9.1 requires specific stormwater quality targets to be Irban Stormwater Improvement Conceptualisation (MUSIC), it is proposed that treatment products equal to Urban Stormwater Assets o address water quality improvement parameters in a satisfactory manner.
 a minimum 5000L rainwater tank to an infiltration/absorption system to a bioretention system to capture al Council engineering advice obtained 	- Development Control Plan 2021 - Part I-9 Water Sensitive Design, Table I-9.4 for residential lots requires either to capture at least 50% of total roof area OR t least 80% of total roof area d on 20 APR 2023 indicates infiltration and bioretention would not be considered efficient options for the site. rainwater storage capturing more than 50% of total roof area will be provided for the development, in addition to a stormwater
detention tank reducing site dischart	ge to the street drainage system.
to be implemented. During construct with the Landcom publication Soils of Temporary construction measures to - Sediment fencing on the low side of	
	ent characteristics and cleaning of sediment deposits as required during construction

ORIFICE DIAMETER =	300 mm
MINIMUM INTERNAL TANK AREA =	111 m2
REQUIRED STORAGE VOLUME =	69 m3
SITE AREA =	3784 m2
EXISTING IMPERVIOUS PROPORTION =	18 %
PROPOSED IMPERVIOUS PROPORTION =	72 %

	BUILDING SERVICES ENGINEER	DESIGNED IY CHECKED MS	PROJECT MULTI-DWELLING HOUSING DEVELOPMENT 10-16 ALBERT STREET,	DRAWING TITLE STORMWATER SERVICES DETAIL SHEET 1			
oration	Sydney Melbourne Manila L1, 15 Atchison Street, St Leonards NSW 2065 Ph: (02) 9437 1022 general@erbas.com.au www.erbas.com.au	NORTH POINT	CASINO NSW (RICHMOND VALLEY COUNCIL) CLIENT PROJECT REFERENCE: BGZDZ	SCALE at B1 PROJECT No. DRAWING - DATE MAY 2023 DRAWN IY DRAWN			

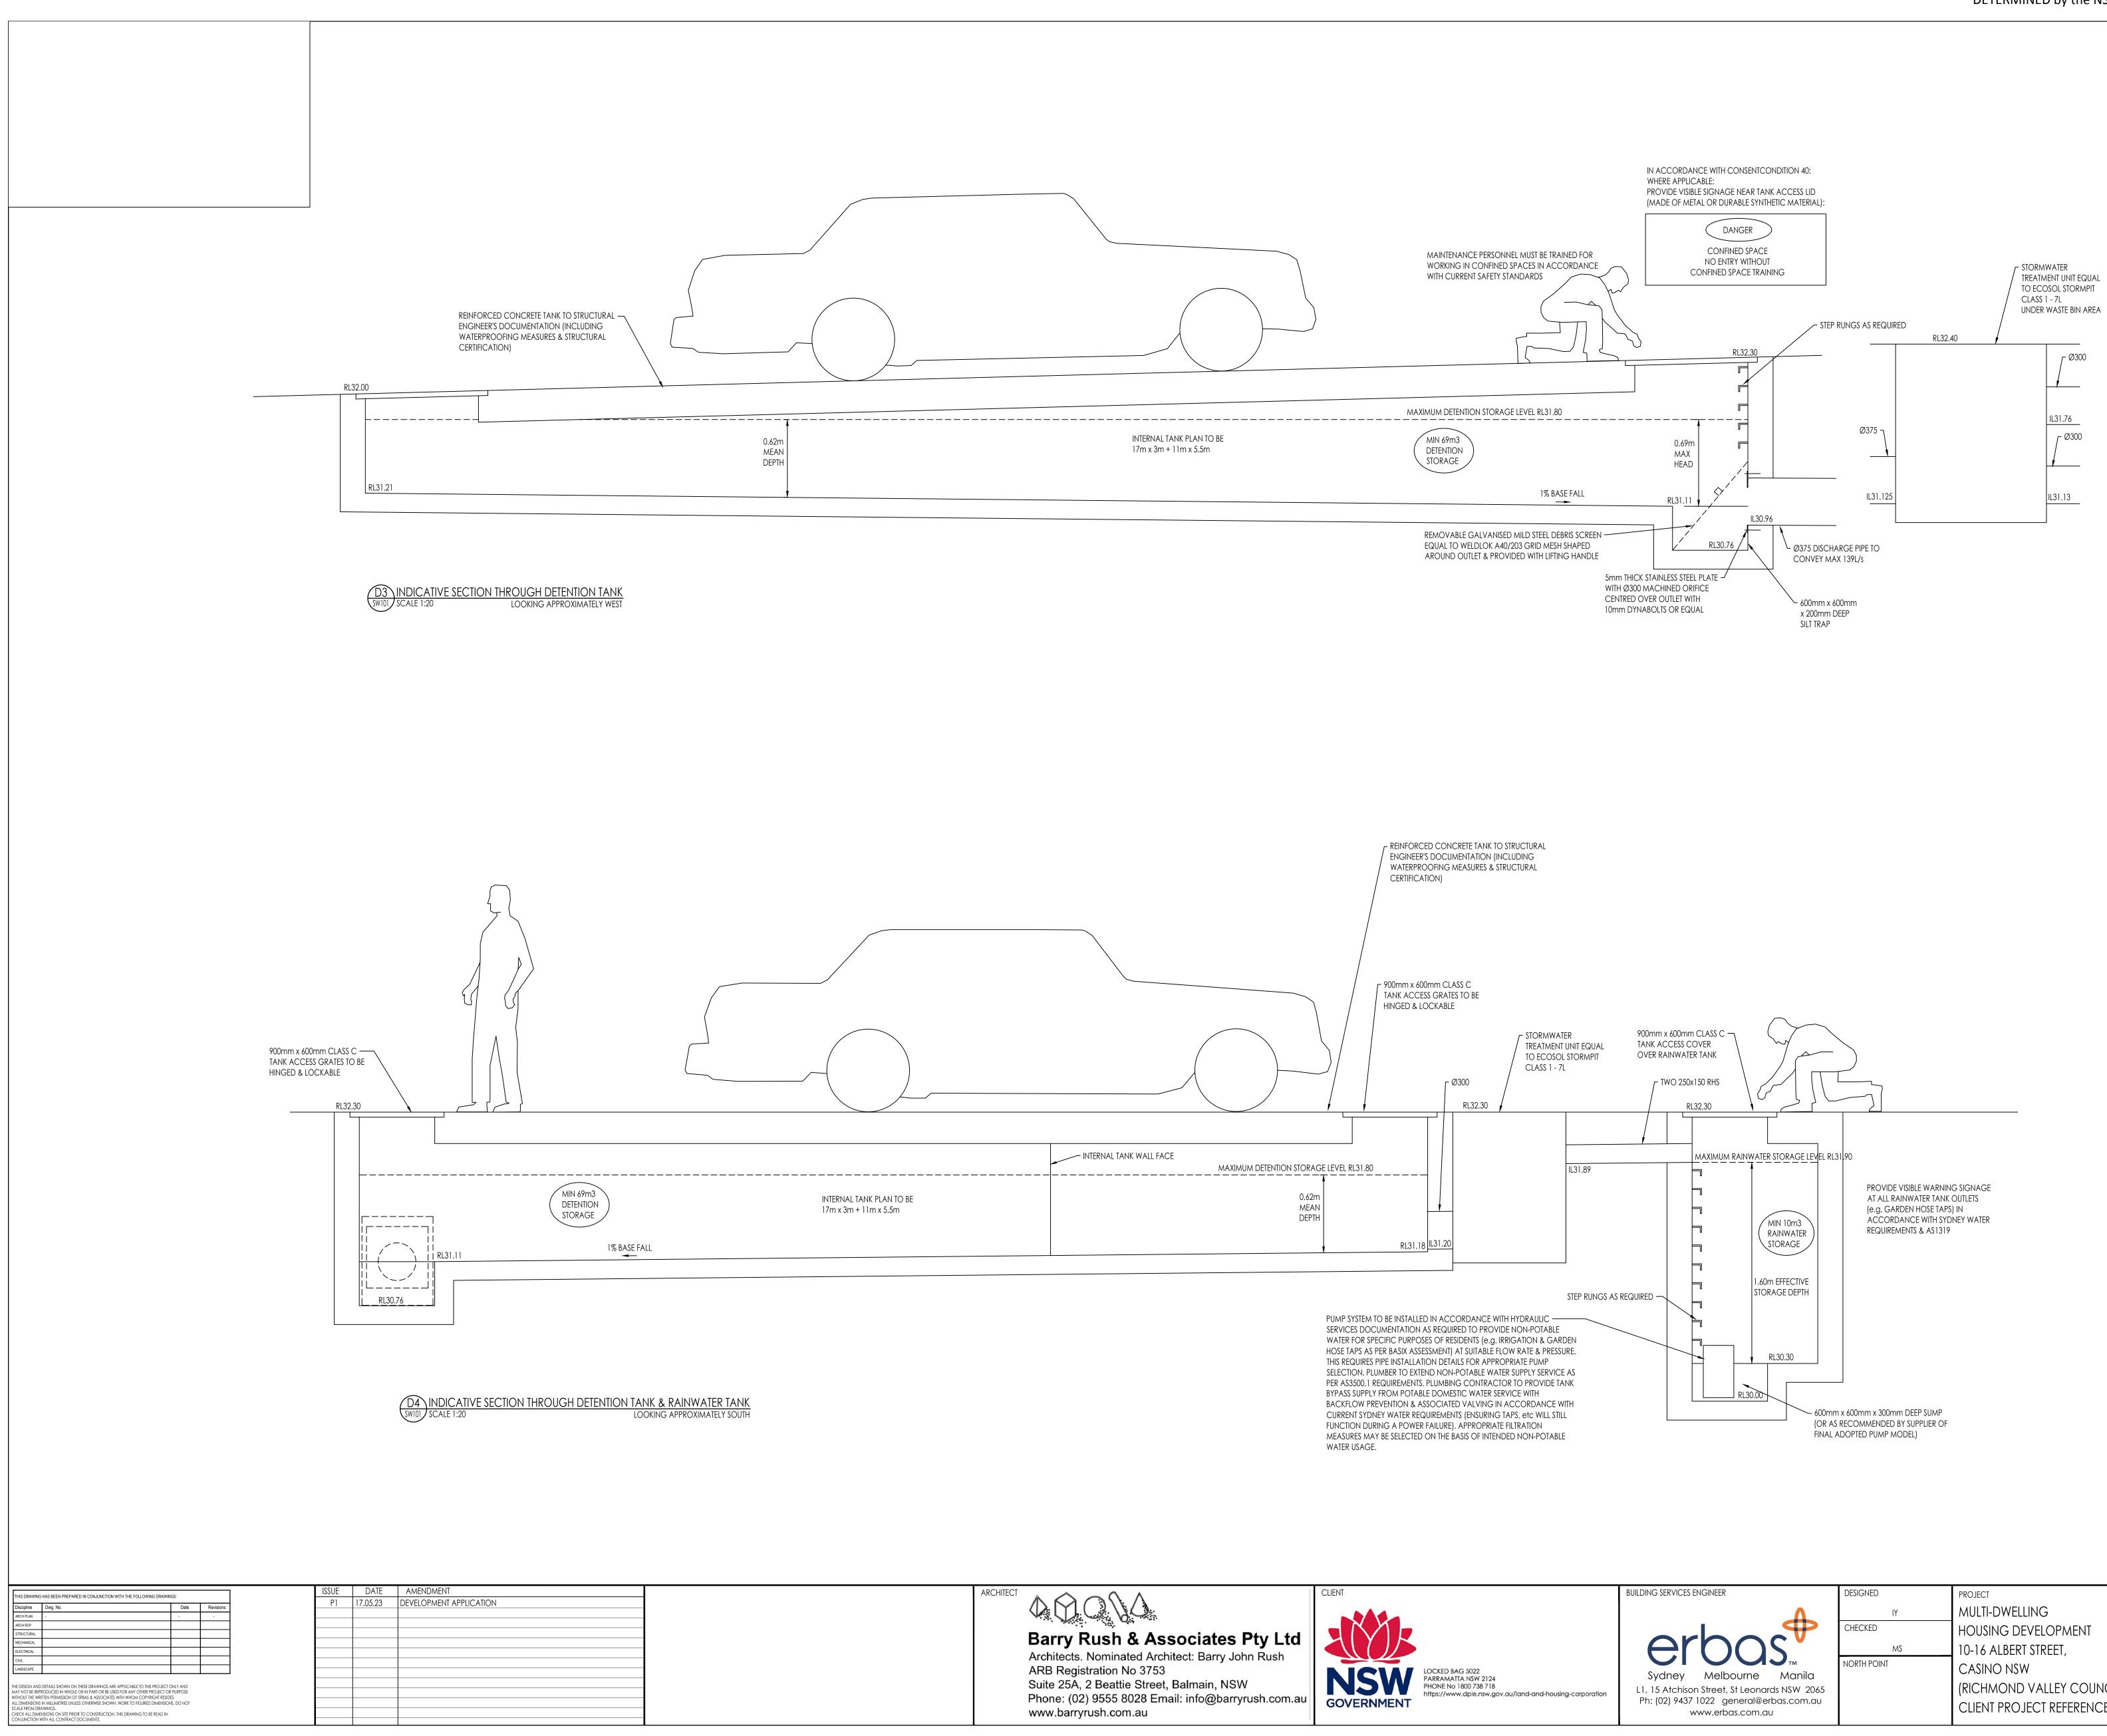

	BUILDING SERVICES ENGINEER	DESIGNED IY CHECKED MS	PROJECT MULTI-DWELLING HOUSING DEVELOPMENT 10-16 ALBERT STREET,	DRAWING TITLE STORMWATER SERVICES DETAIL SHEET 2			
-corporation	Sydney Melbourne Manila L1, 15 Atchison Street, St Leonards NSW 2065 Ph: (02) 9437 1022 general@erbas.com.au www.erbas.com.au	NORTH POINT	CASINO NSW (RICHMOND VALLEY COUNCIL) CLIENT PROJECT REFERENCE: BGZDZ	SCALE at B1 PROJECT No. DRAWING - DATE MAY 2023 DRAWN IY DRAWN			



STORMWATER PIPE SCHEDULE

	R PIPE SI2 ent of runc								7)											
PROJECT:	10-16 ALBE	ERT ST	CASINO																	
Design ra ARI = 100	ainfall int) years	tensity Fy =			_		ess k = 0. ty = 55.8													
U/S NODE	D/S NODE	AREA m2	IMPERV %	COEF	SLOPE %	INFLOW L/s	PIPEFLOW L/s	CAP L/s	SIZE mm	U/S NODE D/S	NODE 2	AREA : m2	IMPERV	COEF	SLOPE %	INFLOW L/s	PIPEFLOW L/s	CAP L/s	SIZE mm	
$\begin{array}{c}1\\2\\3\\4\\5\\6\\7\\8\\9\\10\\11\\2\\13\\14\\5\\16\\17\\8\\9\\20\\12\\23\\4\\5\\6\\7\\8\\9\\0\\1\\2\\23\\4\\5\\6\\7\\8\\9\\0\\1\\2\\3\\3\\4\\5\\6\\7\\8\\9\\0\\4\\1\\4\\2\\4\\4\\4\\5\\6\\7\\8\\9\\0\\5\\1\\5\\2\\5\\3\end{array}$	2 3 4 5 6 7 8 9 0 112 3 4 5 6 7 8 9 0 112 3 4 5 6 7 8 9 0 112 3 4 5 6 7 8 9 0 112 3 4 5 6 7 8 9 0 112 3 4 5 6 7 8 9 0 112 3 4 5 6 7 8 9 0 112 3 4 5 6 7 8 9 0 112 3 4 5 6 7 8 9 0 112 3 4 5 6 7 8 9 0 112 3 4 5 6 7 8 9 0 112 3 4 5 6 7 8 9 0 12 2 2 2 2 2 2 2 2 2 2 2 2 2 2 2 2 2	$ \begin{smallmatrix} 6 & 6 & 6 \\ 6 & 6 & 2 \\ 2 & 7 & 2 & 7 \\ 2 & 5 & 2 & 5 \\ 2$	100 100 100 100 100 100 100 100 100 100	$\begin{array}{c} 1.00\\$	$\begin{array}{c} 1.00\\$	$\begin{array}{c} 0.5\\ 0.5\\ 0.5\\ 0.5\\ 0.5\\ 1.7\\ 2.1\\ 2.1\\ 2.1\\ 2.1\\ 1.9\\ 1.9\\ 1.9\\ 1.9\\ 1.9\\ 1.9\\ 1.9\\ 1$	$\begin{array}{c} 0.5\\ 0.9\\ 1.4\\ 1.9\\ 2.3\\ 4.0\\ 6.1\\ 8.2\\ 10.3\\ 12.2\\ 14.1\\ 16.1\\ 17.5\\ 19.4\\ 21.3\\ 23.2\\ 24.6\\ 28.5\\ 9.1\\ 11.0\\ 39.8\\ 42.5\\ 3.9\\ 9.1\\ 11.0\\ 39.8\\ 42.5\\ 3.9\\ 11.0\\ 39.8\\ 42.5\\ 3.9\\ 11.0\\ 39.8\\ 5.3\\ 9.1\\ 11.0\\ 39.8\\ 5.3\\ 9.1\\ 11.0\\ 39.8\\ 5.3\\ 1.2\\ 1.7\\ 2.0\\ 3.6\\ 5.7\\ 10.0\\ 12.1\\ 14.3\\ 17.8\\ 4.6\\ 9.1\\ 27.0\\ 1.7\\ 9.4.6\end{array}$		$\begin{array}{c} 100\\ 100\\ 100\\ 100\\ 100\\ 100\\ 150\\ 150\\$		R VALUES 82 83 84 85 86 87 88 89 90 101 92 93 94 95 96 97 122 99 100 101 119 103 104 105 106 118 109 117 111 112 116 117 118 109 122 121 122 123 124 125 126 132 128 129 130 131 132 000	S CONTI 23 23 23 23 23 23 23 23 23 23 23 23 23	<pre>INUED > 100 100 100 100 100 100 100 100 100 10</pre>	1.00 1.00 1.00 1.00 1.00 1.00 1.00 1.00	$\begin{array}{c} 1.00\\$	1.8 1.8 1.8 1.7 1.2 1.7 0.0 0.0 2.7 1.9 1.9 1.9 1.9 1.9 1.9 1.9 1.9 1.9 1.9	4.9 6.7 8.5 10.3 12.0 13.1 14.8 47.4 74.4 130.2 2.7 4.5 6.4 7.9 8.8 9.8 12.2 12.4 19.8 28.9 94.0 1.0 1.7 2.8 3.8 4.5 4.8 5.6 7.7 2.7 21.8 3.8 4.5 4.8 5.6 7.7 2.7 21.8 3.0 27.4 35.1 39.6 133.6 0.7 2.5 AX139.0 139.0 139.0 139.4 1.0 139.4 1.0 1.3 1.0 1.3 9.6 1.0 1.3 9.6 1.3 1.0 1.3 9.6 1.0 1.3 9.0 1.3 1.0 1.3 9.6 1.3 1.0 1.3 9.6 1.3 1.0 1.3 9.6 1.3 1.0 1.3 9.0 1.3 9.0	$\begin{array}{c} 8.0\\ 8.0\\ 23.7\\ 183.7\\ 142.8\\ 152.7\\ 23.7$	$\begin{array}{c} 150\\ 150\\ 150\\ 150\\ 150\\ 150\\ 150\\ 150\\$	
54 55 56 57 58 59 60 61 62 63 64 65 66 67 68 69 70 71 72 73 74 75 76 77 78 980	55 56 77 58 59 60 61 62 63 64 65 76 67 68 970 71 72 73 74 75 76 77 88 980 81	24 22 14 20 20 3 38 3 6 3 20 20 22 22 22 3 7 3 31 3 6 3 31 3 6 3 40 0 0 4 14 23	$ \begin{array}{r} 100\\ 100 10$	1.00 1.00	1.00 1.00	$ \begin{array}{c} 1.9\\ 1.7\\ 1.1\\ 1.5\\ 1.5\\ 0.2\\ 2.9\\ 0.2\\ 0.5\\ 0.2\\ 1.5\\ 1.5\\ 1.7\\ 1.7\\ 0.2\\ 0.5\\ 0.2\\ 2.4\\ 0.2\\ 2.8\\ 0.2\\ 3.1\\ 0.0\\ 0.0\\ 0.3\\ 1.1\\ 1.8\end{array} $	$\begin{array}{c} 6.4\\ 8.1\\ 9.2\\ 1.5\\ 3.1\\ 3.3\\ 6.3\\ 6.5\\ 6.9\\ 7.2\\ 8.7\\ 10.3\\ 1.7\\ 3.4\\ 3.6\\ 4.2\\ 4.4\\ 6.8\\ 7.0\\ 9.8\\ 10.0\\ 13.1\\ 23.4\\ 32.6\\ 0.3\\ 1.4\\ 3.2 \end{array}$	$\begin{array}{c} 8.0\\ 23.7\\ 23.7\\ 8.0\\ 8.0\\ 8.0\\ 8.0\\ 8.0\\ 8.0\\ 8.0\\ 8.0$	100 150 100 100 100 100 100 100 100 100	 STORMWATER DF SUBSOIL DRAINA CONFIRM ALL SU ALL DRAINAGE T THE ENTIRE DRAIN ALL GMS RHS CC WATERTIGHT INSF BUILDER TO PROV TO BE MARKED V FINAL DRAINAGE WHERE APPLICAI 	HITE ROUGHNE SLOPE OF 0.50 BASED ON AR TICALITY OF PIF RMWATER DRA RAINAGE TO B AGE (WHERE RE JBSOIL DRAINA TO BE MIN Ø10 NAGE INSTALL/ ONDUITS TO BE PECTION OPEN VIDE 'AS BUILT' WITH RED INK TO E LAYOUT SHAL BLE, BUILDER TO S SHOULD BE A FROM THE REL NG/SURVEY OF DRAINING TO O CHANGE TO D	SS k = 0.150r OR 0.0% OR 1.0% I CHITECTURA PE INSTALLAT AINAGE TO B E SEWER GR. QUIRED) TO AGE REQUIRE 0 UNLESS NC ATION SHALL MIN 4mm TH UNGS OR PIT DRAWINGS O INDICATE L BE MARKE O PAY ALL R ARRANGED IT EVANT PART E COMPLETE THE STORAC DETENTION D	mm FOR GAL IS ASSUMED F AL & SURVEY ION & ADVIS E SEWER GR/ ADE UPVC W BE SLOTTED I EMENTS PRIOI DTED OTHERW COMPLY W HICK. IS TO BE PRO OF ALL RELEY CHANGES TO D ON AS-BUI OAD OPENIN N ACCORDA TY THAT THE C D WORKS SHI GE SYSTEM SH DISCHARGE C	LVANISED MIL FOR CALCULA DRAWINGS. SE OF ANY DIS ADE UPVC WI VITH SOLVENT UPVC WITH FIL R TO CONSTR WISE. ENSURE F ITH THE RELEV VIDED FOR C VANT DRAINA D THE ORIGIN, ILT DRAWINGS NG & COUNC ANCE WITH CO CURRENT HOU OULD BE MADE CONTROL SHA	D STEEL (GMS) FC ATION PURPOSES. SCREPANCY PRIO TH SOLVENT WELE WELDED JOINTS L LTER SOCK LAID IN UCTION & COOR PIPE BENDS GENEL ANT PROVISIONS LEANING PURPOS AGE WORKS AS RE AL DESIGN LAYOU S AS REQUIRED FC CIL FEES ASSOCIAT DNSENT CONDITIO RLY RATE FEE WILL DE AVAILABLE TO E WATERTIGHT BEL LL BE SUBMITTED T	R TO CONSTRUC DED JOINTS SUPF AID ON GRANU N FREE-DRAINING DINATE WITH FO RALLY DO NOT E OF AS3500.3. SES AT MAXIMUN EQUIRED FOR CE JT. DR CERTIFICATIO ED WITH REQUIR DNS & CERTIFIER L BE PAID. VIEW PRIOR TO OW THE MAXIMI TO CONSULTANT	PORTED AS PER AS LAR BEDDING TO A G GRANULAR MATI OTING LEVELS WHE EXCEED 45 DEGREE A 30m INTERVALS & RTIFICATION PURPO N & REFERENCE PU ED CONSTRUCTION S REQUIREMENTS, N ARRANGING FOR F JM WATER STORAC	AS3500.3 CLAUS ERIAL TO AS350 ERE APPLICABLE IS IN PLAN. IN ACCORDAT OSES. IN SOME RPOSES. N. WITH REASONA FINAL SITE INSPE GE LEVEL. RIOR TO INSTAL	SE 6.3.1.2. 10 CLAUSE 6.3 E. NCE WITH AS CASES COUI BLE ADVANC ECTION. LATION.	S3500.3 CLAUSE 7.4.1. INCIL MAY REQUIRE APPROVED PLANS CE NOTICE BEING GIVEN & WRITTEN

	S HAS BEEN PREPARED IN CONJUNCTION WITH THE FOLLOWING DRAWIN	100		ISSUE	DATE	AMENDMENT
				P1	17.05.23	DEVELOPMENT APPLICATION
Discipline	Dwg. No.	Date	Revisions			
ARCH PLAN	-	-	-			
ARCH RCP						
STRUCTURAL						
MECHANICAL						
ELECTRICAL						
CIVIL						
LANDSCAPE						
MAY NOT BE REF WITHOUT THE WE ALL DIMENSIONS SCALE FROM DR CHECK ALL DIME	D DETAILS SHOWN ON THESE DRAWINGS ARE APPLICABLE TO THIS PROJECT RODUCED IN WHOLE OR IN PART OR BE USED FOR ANY OTHER PROJECT OF TITEN PERMISSION OF ERBAS A SOSCIATES WITH WHOM COPYRIGHT RESID SI M MILLMETRES UNLESS OTHERWISE SHOWN. WORK TO HIGURED DIMENSION AWINGS. BRIGONS ON SITE PRIOR TO CONSTRUCTION. THIS DRAWING TO BE READ IN WITH ALL CONTRACT DOCUMENTS.	R PURPOSE ES.				



Label	No:	Pit Size	Surface RL	Outlet IL	Pit Depth	Lid Type	Load Class
SWP	1	900x600	31.30	30.70	600	Cover	А
SWP	2	900x600	31.90	30.77	1130	Cover	А
SWP	3	450x450	31.25	30.82	430	Grate	А
SWP	4	450x450	31.35	30.84	510	Grate	А
SWP	5	450x450	31.60	31.05	550	Grate	А
SWP	6	450x450	31.90	31.40	500	Grate	А
SWP	7	450x450	32.20	31.70	500	Grate	А
SWP	8	450x450	32.70	32.20	500	Grate	А
SWP	9	450x450	33.00	32.50	500	Grate	А
SWP	10	450x450	33.20	32.64	560	Grate	А
SWP	11	450x450	33.25	32.75	500	Grate	А
SWP	12	600x600	32.80	32.10	700	Grate	С
SWP	13	450x450	32.20	31.70	500	Grate	А
SWP	14	450x450	32.40	31.90	500	Grate	А
SWP	15	450x450	32.60	32.10	500	Grate	А
SWP	16	450x450	33.00	32.50	500	Grate	А
SWP	17	450x450	33.50	33.00	500	Grate	А
SWP	18	450x450	33.70	33.20	500	Grate	А
GTD	1	300 WIDE	31.00	30.61	390	Grate	С
GTD	2	150 WIDE	31.50	VERTICAL	MIN 100	Grate	А
GTD	3	300 WIDE	31.80	31.29	510	Grate	А
GTD	4	150 WIDE	32.15	VERTICAL	MIN 100	Grate	А
GTD	5	300 WIDE	32.15	31.25	900	Grate	С
GTD	6	150 WIDE	32.60	VERTICAL	MIN 100	Grate	А
GTD	7	150 WIDE	33.00	VERTICAL	MIN 100	Grate	А
GTD	8	150 WIDE	33.25	VERTICAL	MIN 100	Grate	А
GTD	9	150 WIDE	33.20	VERTICAL	MIN 100	Grate	А
GTD	10	150 WIDE	31.75	VERTICAL	MIN 100	Grate	А
GTD	11	150 WIDE	32.19	VERTICAL	MIN 100	Grate	А
GTD	12	150 WIDE	32.90	VERTICAL	MIN 100	Grate	А
GTD	13	150 WIDE	32.10	VERTICAL	MIN 100	Grate	А
GTD	14	150 WIDE	32.20	VERTICAL	MIN 100	Grate	А
GTD	15	150 WIDE	32.23	VERTICAL	MIN 100	Grate	А

STORMWATER PIT SCHEDULE

1. PITS TO BE IN ACCORDANCE WITH AS3500.3 2. GRATES GENERALLY TO BE HINGED GALVANISED MILD STEEL EQUAL TO BR DURHAM & SONS (ADOPT HEELPROOF STYLE WHERE APPLICABLE)

3. COORDINATE REBATE & CHANNEL DIMENSIONS WITH SLAB CONSTRUCTION TO SUIT TRENCH DRAIN DIMENSIONS AS NECESSARY (WITH STRUCTURAL ENGINEER'S APPROVAL/SUPERVISION) 4. FALL BASE OF TRENCH DRAINS TO OUTLET AT MIN 1%.

5. LIAISE WITH BUILDER TO ENSURE CONCRETE WORKS ASSOCIATED WITH PIT/TRENCH

LOCATIONS ARE ACCURATELY COORDINATED AS REQUIRED. 6. GENERALLY GRADE SURROUNDING SURFACES TO DIRECT STORMWATER INTO GRATES.

7. MINIMUM LOAD CLASS RATINGS ARE PROVIDED. IF A SPECIFIC LOAD CLASS IS NOT COMMERCIALLY AVAILABLE, ADOPT THE NEXT HIGHER LOAD CLASS.

8. PROVIDE STEP RUNGS WHERE PIT DEPTH EXCEEDS 1.2m.

